



BEARINGS ARE ASTRONOMIC AND ARE REFERRED TO THE SOUTHWESTERLY LIMIT OF HIGHWAY 50, HAVING A BEARING OF N44°49'07"W ACCORDING TO PLAN 43R-15539

ELEVATION NOTE:

ELEVATIONS ARE GEODETIC AND ARE REFERRED TO THE TOWN OF CALEDON BENCHMARK NO. 00819758057, HAVING A PUBLISHED ELEVATION OF 251.929 METRES.

LEGEND

MAX. ANGLE OF REPOSE SHOULD BE

- INSPECT STOCKPILES AS SOON AS POSSIBLE FOLLOWING A STORM THAT CAUSES EROSION AND PERFORM NECESSARY
- MAINTENANCE. FREQUENT OBSERVATION AND MAINTENANCE ARE NECESSARY TO MAINTAIN BMPs (BEST MANAGEMENT PRACTICES) IN EFFECTIVE OPERATION CONDITION.

	KIOSK		
	PROPOSED CATCHBASIN MANHO		
	PROPOSED CATCHBASIN		
\Diamond	STREET LIGHT		
	PROPERTY BOUNDARY		
— SILT—	SILT FENCE		
	MUD MAT		
	BARRIER CLIRR		

HYDRANT AND VALVE

VALVE & CHAMBER

O PROPOSED STORM MANHOLE

PROPOSE SANITARY MANHOLE

CATCHBASIN WITH BUFFER

▲ VALVE & BOX


SEDIMENT BAG NOTE:

- INSPECT DAILY DURING ACTIVE PUMPING INTO THE BAG TO ENSURE THAT THERE ARE NO TEARS OR LEAKS IN THE SEALS OR THE BAG, AND ALSO CHECK THAT THE DISCHARGE FROM THE BAG IS NOT CAUSING EROSION UNDERNEATH IT OR ANYWHERE ALONG THE FLOW PATH FROM THE BAG TO THE RECEIVER. KEEP A RECORD OF THE INSPECTION.
- WHERE THERE IS EVIDENCE OF EROSION, RE-CONSIDER WHETHER STABILIZATION IS ADEQUATE TO PROTECT AGAINST EROSION BASED ON THE FLOWS COMING OUT OF THE BAG. CONFIRM THAT THE PUMPS AND BAG SIZE ARE CONTINUING TO PROVIDE THE DESIRED LEVEL OF WATER TREATMENT. WHERE SEDIMENT LEVELS IN DISCHARGED WATER REMAIN ELEVATED, CONSIDER ADDING OR REPLACING WITH A DIFFERENT DEWATERING PRACTICE (E.G. WEIR TANKS) TO PROVIDE ADDITIONAL SEDIMENT REMOVAL. INSPECT BAG TO DETERMINE WHETHER IT IS FULL AND REQUIRES REPLACEMENT.
- WHERE THE BAG IS DAMAGED OR NO LONGER FUNCTIONING, CEASE PUMPING IMMEDIATELY AND REPLACE OR REPAIR COMPONENTS. REPLACE THE BAG ONCE IT'S NOT FUNCTIONING AND/OR ACCORDING TO THE MANUFACTURER'S INSTRUCTIONS. IF THE FLOW THROUGH RATE BEGINS TO DECLINE SIGNIFICANTLY THAT MAY INDICATE THE BAGS IS FULL AND REQUIRES REPLACEMENT. THE AMOUNT OF SEDIMENT CONTAINED IN THE BAG CAN ALSO BE CONFIRMED ONCE PUMPING IS CEASED AND THE BAG IS
- LEFT TO DRAIN. . KEEP ADDITIONAL BAG(S) ON SITE SO THAT REPLACEMENT CAN BE HANDLED QUICKLY WHEN
- 6. ANY REPAIR OR MAINTENANCE NEEDS IDENTIFIED SHOULD BE REPAIRED WITHIN 48 HOURS OR SOONER IF NATURAL RECEPTORS ARE AT IMMINENT AND FORESEEABLE RISK OF ADVERSE IMPACT.

DECOMMISSIONING

- ALLOW BAG TO DRAIN OVER TIME UNTIL THE BULK OF THE WATER IS GONE. . REMOVE BAG WITH MINIMAL DISTURBANCE TO STABILIZED AREAS OR NEARLY NATURAL FEATURES. THE FULL BAG
- SHOULD NEVER BE LIFTED OVER A WATER FEATURE OR A PERSON. DISPOSE OF OR REUSE SEDIMENT BASED ON ITS QUALITY AND THE REQUIREMENTS STATED IN SOIL POLICY AND LEGISLATION.
- 4. PROPERLY DISPOSED OF THE SEDIMENT BAG.

5. CLEAN AND RESTORE THE SEDIMENT BAG LAY DOWN AREA.

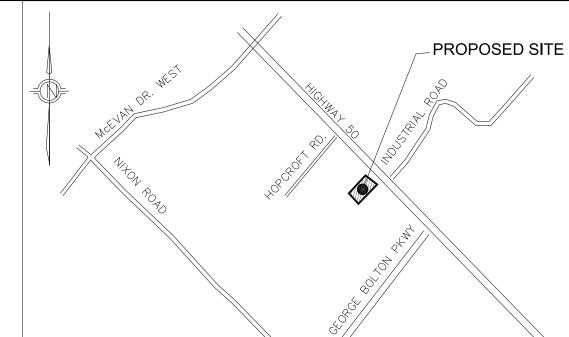

KEY PLAN SCALE: NTS

<u>APPLICANT:</u>

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MUNICIPAL ADDRESS & LEGAL DESCRIPTION

12544 HIGHWAY 50. BOLTON. ONTARIO

REGISTERED PLAN - PART 1 PLAN OF PART OF LOT 3 CONCESSION 6 (GEOGRAPHIC TOWNSHIP OF ALBION) TOWN OF CALEDON (REGIONAL MUNICIPALITY OF PEEL)

OWNER:

RAGBIR GULATHY 12544 HWY 50 BOLTON, ONTARIO

TOPOGRAPHIC INFORMATION:

TOPOGRAPHIC INFORMATION TAKEN FROM GTA GREATER TORONTO ACRES SURVEYING

7003 STEELES AVE. WEST UNIT-12, TORONTO ON M9W 0A2 T.: - (416)679-0572 Fax: - (416)679-0573

E-Mail — jw@gtasurveying.ca



TOWN OF CALEDON EROSION AND SEDIMENT CONTROL NOTES

- ALL EROSION AND SEDIMENT CONTROL (ESC) MEASURES MUST BE INSTALLED PRIOR TO THE COMMENCEMENT OF WORKS ON SITE AND SHALL BE MAINTAINED DURING ALL CONSTRUCTION PHASES OF THE WORKS. THE ESC STRATEGIES OUTLINED ON THIS PLAN ARE NOT STATIC AND MAY NEED TO BE UPGRADED/AMENDED AS SITE CONDITIONS CHANGE TO PREVENT SEDIMENT RELEASE OUTSIDE THE WORK AREA. THE TOWN IS TO BE
- THE TOWN, UPDATED PLANS MAY BE REQUIRED THE CONTRACTOR IS TO ASSIGN AN ENVIRONMENTAL MONITOR (EM) TO ASSURE CONSTRUCTION ACTIVITIES COMPLY WITH THE ENVIRONMENTAL PROVISIONS AND AGENCY PERMITS. THE EM WILL BE A QUALIFIED PERSON AS DETERMINED BY THE TOWN AND/OR CONSERVATION AUTHORITY. THE EM SHOULD SUBMIT INSPECTION FORMS ELECTRONICALLY TO THE TOWN AND CONSERVATION

ADVISED OF ANY CHANGES TO ESC MEASURES, AND AT THE DISCRETION OF

AUTHORITY UPON REQUEST. THE CONTRACTOR IS RESPONSIBLE FOR MAINTAINING ALL ESC MEASURES IN WORKING CONDITION AT ALL TIMES TO THE SATISFACTION OF THE TOWN AND/OR CONSERVATION AUTHORITY. ALL DAMAGED ESC MEASURES SHOULD BE REPAIRED AND/OR REPLACED WITHIN 48 HOURS OF THE INSPECTION. THE CONTRACTOR SHALL ROUTINELY INSPECT ALL ESC DEVICES TO ENSURE PROPERTY WORKING ORDER. FREQUENCY OF INSPECTIONS OF ESC MEASURES

DURING EARTHWORKS ACTIVITIES:

IS AS FOLLOWS:

ON A WEEKLY BASIS; PRIOR TO PREDICTED RAINFALL EVENTS;

• FTER EVERY RAINFALL EVENT;

 AFTER SIGNIFICANT SNOWMELT EVENT; AND DAILY DURING EXTENDED RAIN OR SNOWMELT PERIODS.

DURING TIMES OF NO EARTHWORKS ACTIVITY:

ONCE EVERY 2 WEEKS; AFTER SIGNIFICANT SNOWMELT EVENTS;

- AFTER SIGNIFICANT RAINFALL EVENTS (MORE THAN 25MM OF RAINFALL IN A 24 HOUR PERIOD).
- ALL CONSTRUCTION VEHICLES MUST ENTER AND EXIT THE SITE ONLY FROM THE APPROVED ACCESS ROUTE(S) AS SHOWN ON THE PLANS. CONSTRUCTION ACCESS WILL BE MAINTAINED TO THE SATISFACTION OF THE TOWN/REGION. STREET SWEEPING IS REQUIRED AS NEEDED.
- NO CONSTRUCTION ACTIVITY OR MACHINERY SHALL BE ALLOWED BEYOND THE SILT FENCE OR LIMITS OF THE SITE WORKS. THE CONTRACTOR IS RESPONSIBLE TO IMPLEMENT DUST CONTROL MEASURES
- TOWN AND/OR CONSERVATION AUTHORITY. ALL DISTURBED GROUND LEFT INACTIVE FOR 30 DAYS SHALL BE VEGETATED, SUBJECT TO WEATHER CONDITIONS. DISTURBED AREAS ARE TO BE HYDROSEEDED (OR APPROVED EQUIVALENT) TO THE SATISFACTION OF THE TOWN ALL TOPSOIL STOCKPILES SHALL BE SURROUNDED WITH SEDIMENT CONTROL FENCE. THE MAXIMUM SIDE SLOPE SHALL BE 2:1 (H:V). ONCE TOPSOIL

STRIPPING IS COMPLETED THE STOCKPILE SHALL BE VEGETATED, SUBJECT TO

AND CONSTRUCTION BEST PRACTICE GUIDELINES AS APPROVED BY THE


WEATHER CONDITIONS, BY HYDROSEEDED, OR AN APPROVED EQUIVALENT, TO THE SATISFACTION OF THE TOWN. CONTRACTOR SHALL TAKE CARE AND CONTROL SPILLS, FLUIDS AND MATERIALS DURING CONSTRUCTION TO MINIMIZE RISK TO THE ENVIRONMENT.

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PRINCIPAL: NITIN MALHOTRA, ARCHITECT





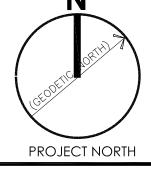

3.	SEP. 2020	ISSUED FOR SPA-IV	AZ
2.	APRIL 2019	ISSUED FOR SPA-III	ΑZ
1.	MARCH 2017	issued for spa	SB
No.	Date	Version	Dwn

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GAS STATION AT 12544 HIGHWAY 50 BOLTON, ON.


DRAWING TITLE:

SPA 2015-006 R2 15-08

EROSION & SEDIMENT CONTROL PLAN

SITE PLAN FILE NUMBER: SC 2003 - 0035		
DRAWN BY: AZ	DATE: 01 FEB. 2019	
CHECKED BY: AZ	SCALE: 1:300	
PROJECT NO.:	DRAWING NO.:	

13-40

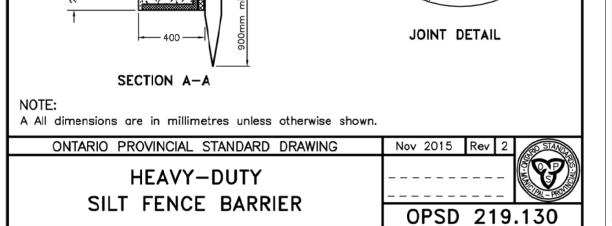


Control measure support -

of geotextile in trench

backfilled and compacted

Trench shall be

Direction of flow

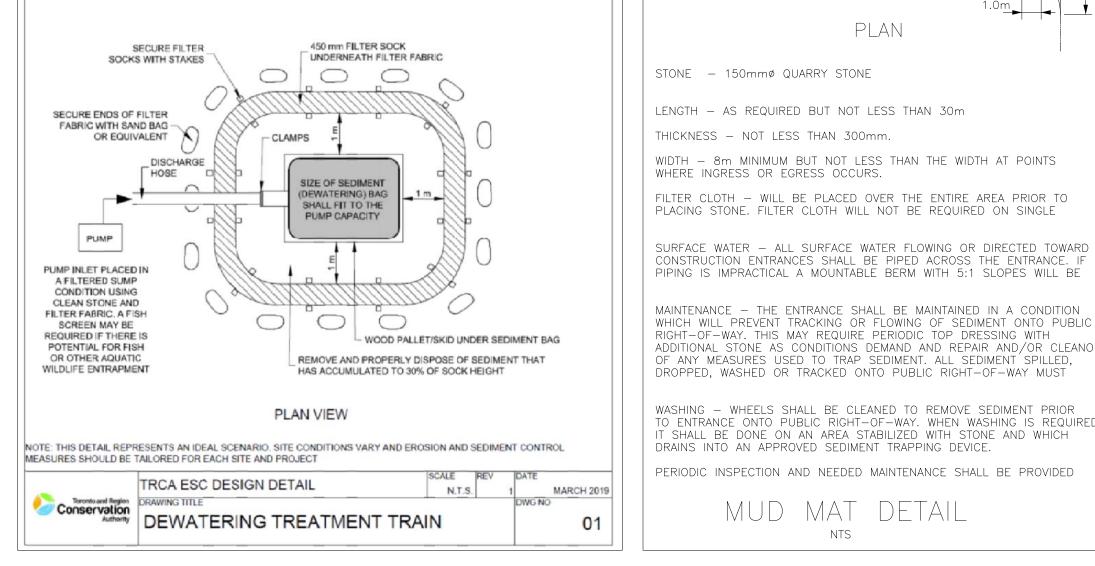

APPROPRIATELY WEIGHTED NON-WOVEN FILTER

SECURE FILTER SOCKS WITH STAKES

SECURE ENDS OF FILTER

FABRIC WITH SAND BAG

OR EQUIVALENT

FABRIC OVERLAP AT TOP OF FILTER SOCK

WOOD PALLET/SKID

SECTION VIEW

UNDER SEDIMENT BAG

450 mm FILTER SOCK -

SECURE FILTER


SOCKS WITH STAKES

DISCHARGE HOSE

SECURE ENDS OF FILTER

FABRIC WITH SAND BAG

OR EQUIVALENT

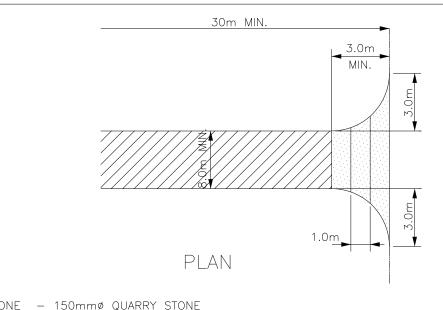

STONE - 150mmø QUARRY STONE

LENGTH - AS REQUIRED BUT NOT LESS THAN 30m THICKNESS - NOT LESS THAN 300mm.

WIDTH - 8m MINIMUM BUT NOT LESS THAN THE WIDTH AT POINTS WHERE INGRESS OR EGRESS OCCURS. FILTER CLOTH - WILL BE PLACED OVER THE ENTIRE AREA PRIOR TO

PLACING STONE. FILTER CLOTH WILL NOT BE REQUIRED ON SINGLE SURFACE WATER - ALL SURFACE WATER FLOWING OR DIRECTED TOWARD

CONSTRUCTION ENTRANCES SHALL BE PIPED ACROSS THE ENTRANCE. IF PIPING IS IMPRACTICAL A MOUNTABLE BERM WITH 5:1 SLOPES WILL BE MAINTENANCE - THE ENTRANCE SHALL BE MAINTAINED IN A CONDITION

ADDITIONAL STONE AS CONDITIONS DEMAND AND REPAIR AND/OR CLEANOUT OF ANY MEASURES USED TO TRAP SEDIMENT. ALL SEDIMENT'SPILLED, DROPPED, WASHED OR TRACKED ONTO PUBLIC RIGHT-OF-WAY MUST WASHING - WHEELS SHALL BE CLEANED TO REMOVE SEDIMENT PRIOR TO ENTRANCE ONTO PUBLIC RIGHT-OF-WAY. WHEN WASHING IS REQUIRED,

T SHALL BE DONE ON AN AREA STABILIZED WITH STONE AND WHICH DRAINS INTO AN APPROVED SEDIMENT TRAPPING DEVICE. PERIODIC INSPECTION AND NEEDED MAINTENANCE SHALL BE PROVIDED

MUD MAT DETAIL