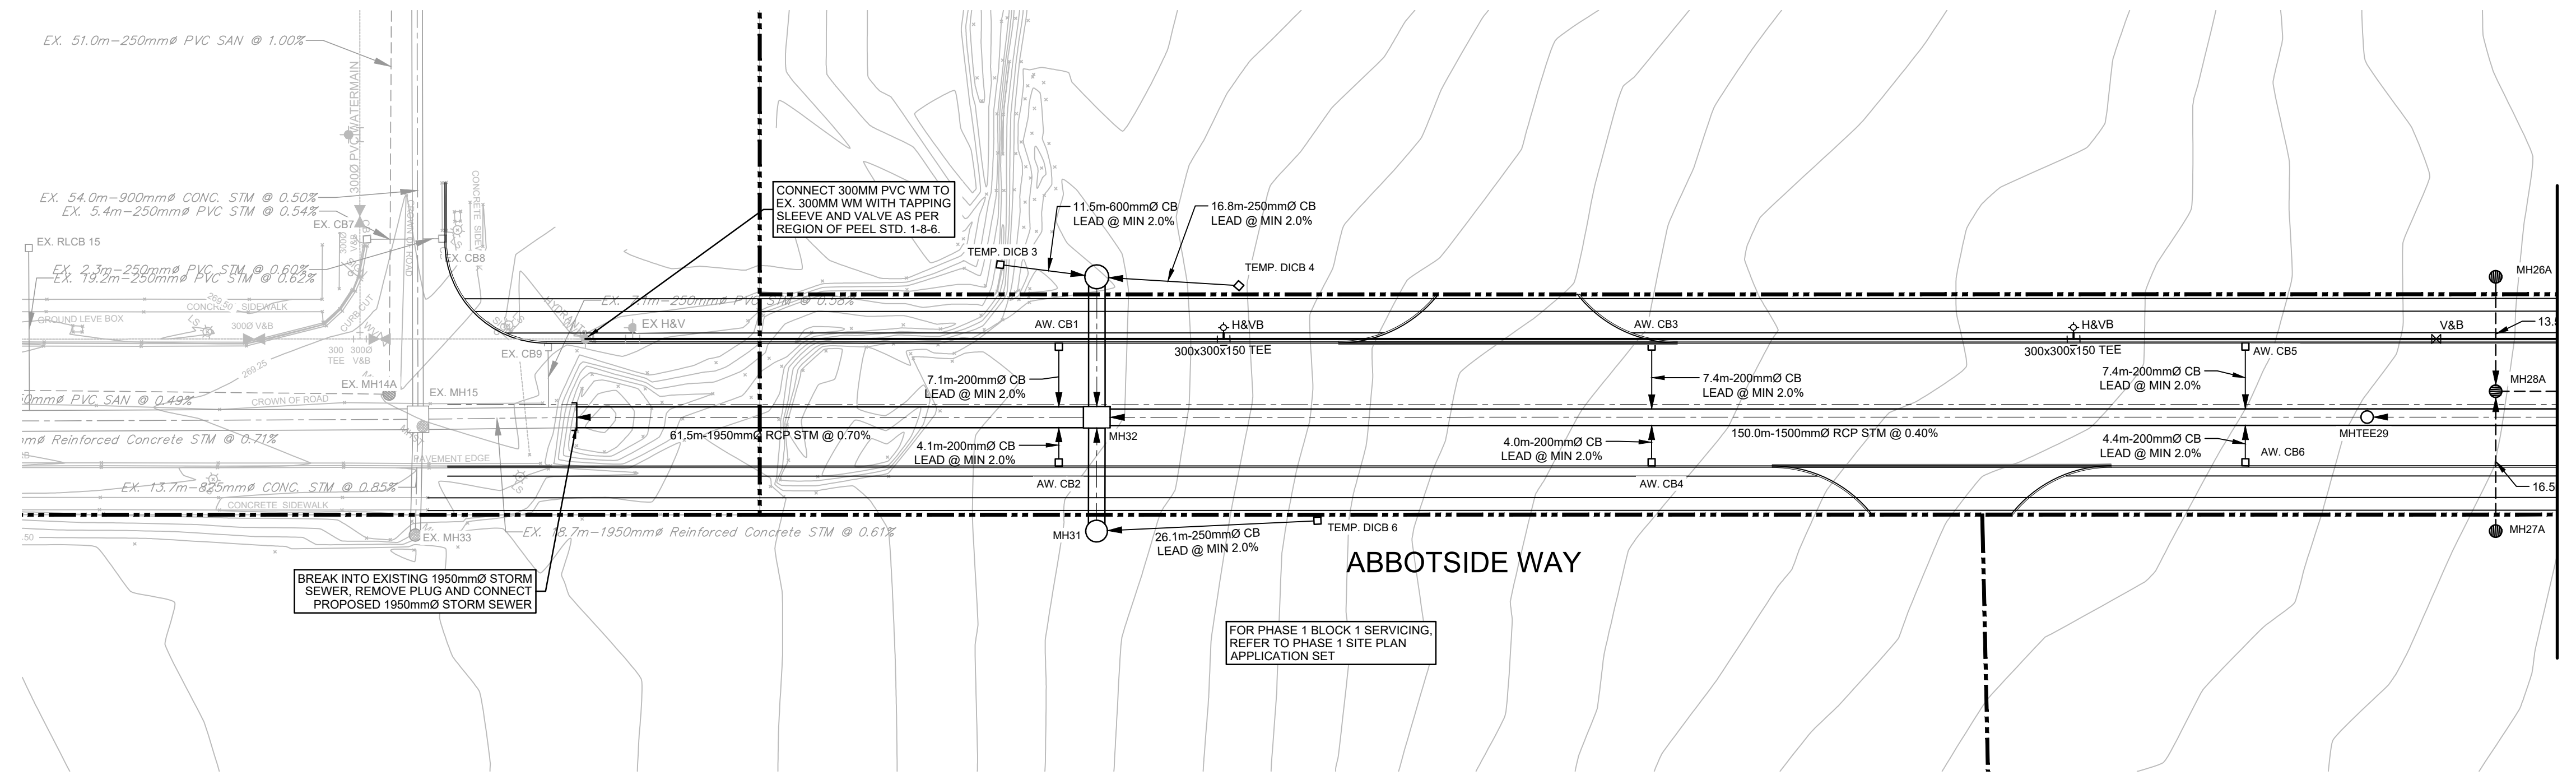
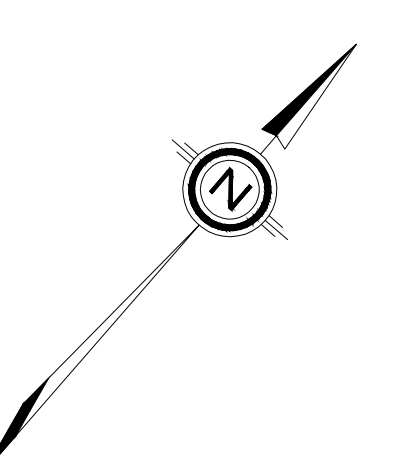


CLIENT  
**BROCCOLINI**  
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MISSISSAUGA, ON. L4W5L6

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SEE DWG. SS-02

ISSUES

No.	DESCRIPTION	DATE
1	ISSUED FOR SPA 1st SUBMISSION	NOV 15, 2021

LEGEND

PROPERTY LINE	---
PROPOSED STORM MANHOLE	○
PROPOSED SANITARY MANHOLE	⊙
PROPOSED SINGLE CATCH BASIN	□
PROPOSED DOUBLE CATCH BASIN	⊠
EXISTING STORM MANHOLE	○
EXISTING SANITARY MANHOLE	⊙
EXISTING CATCH BASIN	□
PROPOSED VALVE AND BOX	V&B
PROPOSED STORM	---
PROPOSED SANITARY	---
PROPOSED WATER	---
EXISTING STORM	---
EXISTING SANITARY	---
EXISTING WATER	---
EXISTING BELL	---
EXISTING GAS	---

STORM SEWER STRUCTURE INVENTORY


MH #	MH DIAMETER	MH OPSD	FRAME OPSD	TOP ELEV.	INVERTS
MH27	2400x3000mm	AS PROVIDED BY MANUFACTURER	401.010	272.01	NW 268.13 (250mmØ) SW 266.88 (1500mmØ)
MH30	2550mmØ	OPSD 701.013	401.010	270.25	SW 265.62 (600mmØ) NE 268.29 (250mmØ) SE 265.52 (1500mmØ)
MH31	2300mmØ	OPSD 701.013	401.010	270.25	NE 268.17 (250mmØ) NW 265.79 (1500mmØ)
MH32	2400x3000mm	AS PROVIDED BY MANUFACTURER	401.010	270.08	NE 265.35 (1500mmØ) NW 265.35 (1500mmØ) SE 265.65 (1500mmØ) SW 264.90 (1950mmØ)
MHTEE28	1200mmØ	OPSD 707.010	401.010	271.41	NE 266.51 (1500mmØ) SW 266.51 (1500mmØ)
MHTEE29	1200mmØ	OPSD 707.010	401.010	270.83	NE 265.95 (1500mmØ) SW 265.95 (1500mmØ)

CATCHBASIN STRUCTURE INVENTORY

CB #	CB STD.	FRAME OPSD	TOP ELEV.
AW. CB1	OPSD 705.010	400.020	269.95
AW. CB2	OPSD 705.010	400.020	269.95
AW. CB3	OPSD 705.010	400.020	270.30
AW. CB4	OPSD 705.010	400.020	270.30
AW. CB5	OPSD 705.010	400.020	270.65
AW. CB6	OPSD 705.010	400.020	270.65
AW. CB7	OPSD 705.010	400.020	271.00
AW. CB8	OPSD 705.010	400.020	271.00
AW. CB9	OPSD 705.010	400.020	271.35
AW. CB10	OPSD 705.010	400.020	271.35
AW. CB11	OPSD 705.010	400.020	271.70
AW. CB12	OPSD 705.010	400.020	271.70
TEMP. DICB 3	OPSD 705.030	403.011	267.62
TEMP. DICB 4	OPSD 705.030	403.011	270.13
TEMP. DICB 5	OPSD 705.030	403.011	270.73
TEMP. DICB 6	OPSD 705.030	403.011	270.19

SANITARY SEWER STRUCTURE INVENTORY

MH #	MH DIAMETER	MH OPSD	FRAME OPSD	TOP ELEV.	INVERTS
MH26A	1200mmØ	OPSD 701.010	401.010	271.05	SE 265.42 (300mmØ)
MH27A	1200mmØ	OPSD 701.010	401.010	271.05	NW 265.45 (300mmØ)
MH28A	1200mmØ	OPSD 701.010	401.010	270.90	NW 265.28 (300mmØ) SE 265.28 (300mmØ) NE 265.18 (300mmØ)
MH29A	1200mmØ	OPSD 701.010	401.010	271.50	SW 264.70 (300mmØ) NE 264.67 (300mmØ)
MH30A	1200mmØ	OPSD 701.010	401.010	272.10	NE 264.18 (250mmØ) SW 264.27 (300mmØ)

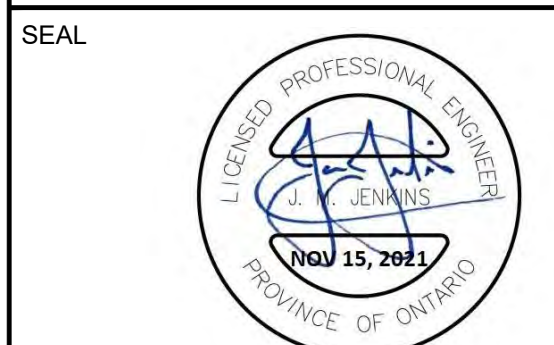

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PROJECT  
**12304 HEART LAKE ROAD**  
CALEDON, ON. L7C 2J2

PROJECT NO:  
**135636**

DRAWN BY: **NDS** CHECKED BY: **JJ**

PROJECT MGR: **JJ** APPROVED BY: **JJ**

LIST OF DRAWINGS  
SG-01 - SITE GRADING PLAN  
SG-02 - SITE GRADING PLAN  
SS-01 - SITE SERVICING PLAN  
SS-02 - SITE SERVICING PLAN  
PP-01 - PLAN PROFILE OF ABBOTTSIDE WAY  
PP-02 - PLAN PROFILE OF ABBOTTSIDE WAY  
EC-01 - EROSION AND SEDIMENT CONTROL PLAN  
EC-02 - EROSION AND SEDIMENT CONTROL PLAN  
DD-01 - GENERAL NOTES AND DETAILS  
DD-02 - GENERAL NOTES AND DETAILS  
DD-03 - GENERAL NOTES AND DETAILS  
DD-04 - GENERAL NOTES AND DETAILS

SITE PLAN INFORMATION  
WARE MALCOMB  
290 UNIVERSITY AVE, SUITE 235  
TORONTO, ON. M9H 3E5  
PHONE: (416) 537-5700  
WEBSITE: www.waremalcomb.com

SUBVEYOR INFORMATION  
RIFE SURVEYING LTD.  
ONTARIO LAND SURVEYORS  
640 CHRISLEA ROAD, SUITE 7  
WOODBRIDGE, ON. L4L 6A3  
PHONE: (416) 835-5000  
WEBSITE: www.rife.ca

BENCHMARK INFORMATION  
ELEVATIONS ARE GEODETIC AND ARE REFERRED TO MTO VERTICAL BENCHMARK NUMBER 05199991 HAVING AN ORTHOMETRIC ELEVATION OF 265.112 METRES. ELEVATIONS ARE REFERENCED TO THE CANADIAN GEODETIC VERTICAL DATUM OF 1984, 1978 ADJUSTMENT (CGVD-1984/1978).

SCALE: 1:500

SHEET TITLE  
**SITE SERVICING PLAN**

SHEET NUMBER  
**SS-01**

ISSUE  
**01**