

TOWN OF CALEDON PLANNING RECEIVED

July 25, 2022

MEMO

TO: Broccolini Construction Toronto Inc.

FROM: Chelsey Tyers, BES, MCIP, RPP, Cultural Heritage Specialist, WSP

SUBJECT: 12304 Heart Lake Road Cultural Heritage Impact Statement Addendum Memo for Phase

1, 2 and Abbotside Way

DATE: July 8, 2022

BACKGROUND

Broccolini Construction Toronto Inc. retained WSP Canada Inc. (WSP) to complete a Cultural Heritage Impact Assessment (CHIS) for proposed development at 12304 Heart Lake Road, Town of Caledon (the subject property). Since completion of the CHIS (October 2021), the client has decided to split the development of the subject property into three phases of development. This CHIS Addendum memo has been prepared to address Phases 1 and 2 of the development as well as the extension of Abbotside Way to Heart Lake Road, all of which are subject to one Draft Plan of Subdivision application.

PHASE 1 AND 2 DEVELOPMENT & ABBOTSIDE WAY

Phase 1 of the development includes a roughly rectangular shaped portion of the southwest corner of the property with a lot area of 9.955 hectares (24.599 acres). Development of Phase 1 includes a warehouse with a footprint of 48, 655.68 m² (Attachment 1). Loading areas and surface parking will be located south of the warehouse and more surface parking will be located north of the warehouse as well as a several parking spaces on the west side of the building.

Phase 2 of the development includes a roughly rectangular-shaped portion of the southeast corner of the property with a lot area of 6.52 hectares (16.11 acres) as well as the connection of Abbotside Way from the adjacent residential subdivision to Heart Lake Road. Development of Phase 2 includes a warehouse with a footprint of 29, 830 m² (321, 087 ft², Attachment 2) with two office spaces. Loading areas will be located at the south side of the warehouse and surface parking will be located along the north, east and south sides of the warehouse.

Phases 1 and 2 will be connected to the residential subdivision to the northwest by the extension of Abbotside Way to Heart Lake Road. The right-of-way will be approximately 26 m wide for the extension of Abbotside Way.

The landscape strategy for Phase 1 and 2 (Attachment 3 & 4) demonstrates a holistic approach to reinforce site identity and the overall development vision; support safety, security, and accessibility; strengthen existing streetscape patterns; provide environmental buffering; and support vegetation connections in the area. Enhanced landscaping along the frontages of Heart Lake Road and the Abbotside Way are intended to complement the building architecture and strengthen the streetscape character in the area. Planting offers varied seasonal interest and utilizes native species to provide visual screening of parking and amenity areas. Accessible access points and pedestrian circulation routes ensure the site is well connected, safe, and supports a pedestrian environment. A more utilitarian approach is applied to the rear of the site, where proposed landscaping is primarily applied as environmental buffering and visual screening from Highway 410.



CULTURAL HERITAGE EVALUATION

As part of the CHIS for 12304 Heart Lake Road (October 2021), the subject property was assessed in accordance with the criteria under Ontario Regulation 9/06 (O. Reg. 9/06) and determined to meet five of the nine criteria. As such, the following Statement of Cultural Heritage Value or Interest was prepared.

STATEMENT OF CULTURAL HERITAGE VALUE OR INTEREST

DESCRIPTION OF HISTORIC PLACE

Located northwest of Highway 410, in the Town of Caledon, 12304 Heart Lake Road sits on approximately 72 acres of a former 100-acre farm on the east half of Lot 19, Concession II in the Geographic Chinguacousy Township.

HERITAGE VALUE

The approximately 72-acre property at 12304 Heart Lake Road continues to reflect the scale of the original 100-acre farm. Its value as a representative nineteenth century farmstead persists through the retention of the agricultural fields, the tree-lined driveway, the mature coniferous and deciduous trees, the nineteenth century stone farmhouse and the nineteenth century bank barn.

The one-and-a-half storey stone farmhouse is estimated to have been constructed between 1877 and 1891. It displays a representative example of a field stone Ontario Gothic Cottage. The one-and-a-half storey height, the symmetrical three-bay facade with central gable peak, the segmentally arched and rectangular two-over-two wood windows, the two-over-two lancet wood window, and the carved stone lintels and sills are all characteristic of this style. The farmhouse also displays a high degree of craftmanship in the details of the carved lintels above the door and windows on the front section of the house.

The barn on the property is a representative example of a Central Ontario bank barn. Built to a rectangular plan with a bank constructed to the north side, the barn exhibits elements consistent with barn construction in Ontario in the mid to late-nineteenth century. Characteristic features of the style include the use of heavy timber framing, a field stone foundation and gable roof along with the two-storey construction housing a lower stable area and a large upper level for crop and implement storage.

Through its function as a farm for at least 130 years, 12304 Heart Lake Road is directly associated with the agricultural development of the former Chinguacousy Township and Town of Caledon. This theme is significant as it historically contributed to the community's early economic growth and continues to be practiced today.

As the property retains 72 acres of the original 100-acre lot and continues to be actively used for agriculture, 12304 Heart Lake Road is important in maintaining the historical agricultural character of the surrounding area. The property is functionally and historically linked to its surroundings as indicated by the presence and placement of the farmhouse and barn, the associated circulation patterns including the tree-lined driveway and the surrounding agricultural fields that continue to reflect the function of the historic nineteenth century farmstead. Additionally, the view from Heart Lake Road along the tree-lined driveway terminates on the east elevation of the barn, providing a significant viewscape.

LIST OF HERITAGE ATTRIBUTES

The cultural heritage attributes that reflect the CHVI of the nineteenth century farmstead cultural heritage landscape at 12304 Heart Lake Road include the:

- Approximately 72-acre irregular lot comprised of agricultural fields;



- Assembly of structures in the middle of the property;
 - o Ontario Gothic Cottage and,
 - o Nineteenth century Central Ontario bank barn.
- Long driveway and coniferous and deciduous trees lining the drive leading from Heart Lake Road to the farmhouse and barn; and
- Mature coniferous trees surrounding the farmhouse.

The cultural heritage attributes that reflect the CHVI of the nineteenth century stone farmhouse as a representative example of an Ontario Gothic Cottage include its:

- One-and-a-half storey massing;
- Cross- gable roof;
- T-shaped footprint;
- Rubble stone construction, parged with plaster to resemble ashlar blocks;
- Symmetrical three-bay façade;
- Centrally placed front entrance including wood paneled door and carved stone lintel.
- Lancet window in gable peak with pointed cut stone molding;
- Segmentally arched two-over-two double-hung-sash wood windows in front portion of the house with carved stone lintels and sills;
- Rectangular window openings in the rear wing with cut stone lintels and sills; and,
- Wood paneled side door on the north elevation.

The cultural heritage attributes that reflect the CHVI of the nineteenth century barn as a representative example of a Central Ontario bank Barn include its:

- Two-storey massing built to a rectangular plan;
- Heavy square timber post and beam framing, wood pulley and shaft, and floor joists;
- North side upper level entrance built into a bank of land;
- Field stone foundation with door and window openings;
- Gable roof; and
- Vertical wood board cladding.

Significant views include:

- The view from Heart Lake Road down the tree-lined driveway terminating at the east elevation of the barn.

IMPACT OF THE PHASE 2 DEVELOPMENT

This memo addresses the impacts of Phase 1, 2 and extension of Abbotside Way on the cultural heritage value or interest of the subject property as was well as the adjacent heritage resources. In addition to 12304 Heart Lake Road, Phase 2 includes 12210 Heart Lake Road which is not designated under the Ontario Heritage Act or included on the Town of Caledon's Municipal Heritage Register. Adjacent heritage resources include 12506 Heart Lake Road and 12689 Heart Lake Road which are listed on the Town of Caledon's Municipal Heritage Register.

The MHSTCI *Ontario Heritage Toolkit: Resources in Land Use Planning Process* identifies seven potential impacts that an undertaking may have on a cultural heritage resource (see Table 4 for the full list).



As neither the MHSTCI nor any other Canadian agency provides guidance on evaluating the magnitude of impact, this memo uses guides published by the *International Council on Monuments and Sites* (ICOMOS) of the United Nations Educational, Scientific and Cultural Organization (UNESCO) from the World Heritage Convention of January of 2011. The grading of impact is based on the "Guide to Assessing Magnitude of Impact" summarized in Table 1 below.

Table 1: Impact Grading

IMPACT GRADING	DESCRIPTION
Major	Change to heritage attributes that contribute to the CHVI such that the resource is totally altered. Comprehensive changes to the setting.
Moderate	Change to many heritage attributes, such that the resource is significantly modified. Changes to the setting of a heritage property, such that it is significantly modified.
Minor	Change to heritage attributes, such that the asset is slightly different. Change to the setting of a heritage property, such that it is noticeably changed.
Negligible/Potential	Slight changes to heritage attributes or the setting that hardly affects it.
None	No change to heritage attributes or setting.

Table 2: Assessment of Impacts

CRITERIA ASSESSMENT

Destruction of any, or part of any,	Subject Property
significant heritage attributes or features;	Impact: Negligible/Potential
	Analysis: The proposed development includes redeveloping approximately 40 acres of the south part of the subject property which consists of agricultural fields associated with 12304 Heart Lake Road and a single detached dwelling addressed as 12210 Heart Lake Road. While the agricultural fields have been identified as a heritage attribute for the contribution they make to the context of the subject property as a nineteenth century farmstead cultural heritage landscape, approximately 50 acres of agricultural fields will remain. Therefore, it is determined that the remaining agricultural fields surrounding the farmhouse and barn are enough to ensure that the property will continue to be a representative example of a nineteenth century farmstead cultural heritage landscape.



CRITERIA ASSESSMENT

	Adjacent Heritage Properties					
	Impact: None					
	Analysis: The proposed development would not require destruction of any part of the adjacent heritage resources.					
Alteration that is not sympathetic, or	Subject Property					
is incompatible, with the historic fabric and appearance;	Impact: Negligible					
	Rationale: An ample agricultural field buffer between the proposed warehouses and Abbotside Way extension, and the farmhouse and barn will help to maintain the historic fabric and appearance of the nineteenth century farm cultural heritage landscape. In addition, the landscaping plan for the proposed development (Attachment 3 and 4) will provide a mixture of deciduous and coniferous trees which will aid in providing a visual buffer between the development and the farmhouse and barn. With the large expanse of agricultural fields and landscape buffer, the potential impacts are considered sufficiently mitigated.					
	Adjacent Heritage Properties					
	Impact: Negligible					
	Rationale: The proposed development will not directly alter any of the adjacent properties, however, the building for Phase 2 will be highly visible from Heart Lake Road. While the Phase 2 building will be visible from Heart Lake Road, the closest adjacent heritage property is approximately 550 m from the proposed development. As such, there is sufficient distance between the proposed development and the adjacent heritage resources that impacts are considered negligible.					
Shadows created that alter the	Subject Property					
appearance of a heritage attribute or change the viability of a natural	Impact: None					
feature or plantings, such as a garden;	Rationale: No shadow impact assessment has been provided, however, given the distance of the proposed development from the farmhouse and barn, no shadow impacts are anticipated.					
	Adjacent Heritage Properties					
	Impact: None					
	Rationale : No shadow impact assessment has been provided, however, given the large size of the adjacent rural properties and the placement of proposed development at the south portion of the subject property, no shadow impacts are expected.					
	Subject Property					
	Pogo 5					



CRITERIA ASSESSMENT **Isolation** of a heritage attribute from Impact: None its surrounding environment, context or a significant relationship; **Rationale:** The proposed development will not isolate any heritage attributes from its surrounding environment, context or any significant relationships. **Adjacent Heritage Properties** Impact: None Rationale: The proposed development will not isolate any of the adjacent heritage properties. **Subject Property** Direct or indirect obstruction of significant views or vistas within, from, or to built and natural Impact: None features; Rationale: The identified view from Heart Lake Road down the driveway towards the barn and farmhouse will not be impacted. **Adjacent Heritage Properties Impact:** None Rationale: The adjacent heritage properties are listed on the Town of Caledon's Heritage Register and have not been subject to detailed cultural heritage evaluation. As such, no significant views or vistas have been identified for these properties. Notwithstanding this, views to the adjacent heritage properties will not be impacted by the proposed development. A change in land use such as **Subject Property** rezoning a battlefield from open space to residential use, allowing **Impact:** Negligible new development or site alteration to fill in the formerly open spaces; **Rationale:** The proposed development will result in the change in land use from agricultural to industrial for the south-most 40 acres of land on the subject property. However, given approximately 50 acres of agricultural land will remain and provide an ample visual buffer around the farmhouse and barn, the context of the farmhouse and barn will be maintained. **Adjacent Heritage Properties** Impact: None **Rationale**: The change in land use for the proposed development will not impact the land use of the adjacent heritage properties. Land disturbances such as a change **Subject Property** in grade that alters soils, and drainage patterns that adversely **Impact:** Potential

affect an archaeological resource.



CRITERIA	ASSESSMENT
	Rationale: If required, the subject property should be subject to an Archaeological Assessment.
	Given the distance of the extant buildings on the property from the proposed development, vibration impacts are not anticipated.
	Adjacent Heritage Properties
	Impact: None
	Rationale: The proposed development will not result in any land disturbance to any of the adjacent heritage properties.

MITIGATION MEASURES

The impact assessment has identified the impacts to the cultural heritage landscape to range from none to negligible. Potential impacts from the visual impact of the proposed development on the cultural heritage landscape have already been sufficiently mitigated by the setback of the proposed development from the farmhouse and barn as well as the landscape buffer that will consist of a mixture of coniferous and deciduous trees. The landscape plans include provision for deciduous trees approximately 60-70 cm diameter and coniferous trees of 200 cm in height, and while they will not block views of the proposed development from installation, they will grow into the space and be able to soften the visual impact in years to come.

SUMMARY OF FINDINGS AND RECOMMENDATIONS

This CHIS Addendum has reviewed the proposed development that consists of Phase 1, Phase 2 and the extension of Abbotside Way for 12304 Heart Lake Road, Town of Caledon. The following has been determined:

- The impact due to the loss of 40 acres of agricultural fields as part of the proposed development is negligible due to the remaining expanse of agricultural fields on the subject property. It is noted that the remaining agricultural fields will be impacted by the Phase 3 development which is included in the CHIS dated October 2021, but this Addendum memo is limited to consideration of the Phase 1 and 2 and the extension of Abbotside Way.
- An archaeological assessment may be required by the Town of Caledon prior to land disturbances.
- There are no impacts to adjacent heritage properties.

WSP has no further recommendations for the Phase 1 and 2 development and the extension of Abbotside Way for 12304 Heart Lake Road.

WSP Canada Inc.

Chelsey Tyers, BES, MCIP, RPP Cultural Heritage Specialist, WSP



Attachments:

- 1- Site Plan for Phase 1 Development
- 2 Site Plan for Phase 2 Development
- **3** Landscape Plan Phase 1 **4** Landscape Plan Phase 2



ATTACHMENT 1 – SITE PLAN FOR PHASE 1 DEVELOPMENT



PROJECT DATA: **DEVELOPMENT STANDARDS:** SITE AREA: ZONING: MP/MS GROSS: 91.52 AC 37.04 HA 370,370 m² MAX. F.A.R.: 3,986,633 SF MAX. COVERAGE: 50% BUILDING AREA: 48,610 m² MAX. HEIGHT: 12.2 m BUILDING 1 523,234 SF FAR: 0.13 BUILDING SETBACKS: GROSS: 0.13 FRONT: 9 m SIDE (INT): COVERAGE: 7.5 m GROSS: 7.5 m NET: **BUILDING 1** 67 PARKING SETBACKS: ▲ DOCK-HIGH DOORS • GRADE-LEVEL DOORS PARKING REQUIRED: SIDE (EXT): 3 m WAREHOUSE 3 m 78 STALLS 7,000 m² <7k m²1.5m 90 STALLS 13,000 m² 7k-20k m² 170 STALLS LANDSCAPE REQ.: 28,610 m² >20k m² 10% TOTAL 338 STALLS OFF-STREET PARKING: 247 STALLS PARKING PROVIDED: DRIVE AISLE: REQ. ACCESSIBLE To be confimed by City 86 STALLS REQ. PARKING RATIO BY USE: TRAILER STALLS WAREHOUSE: \leq 7,000 m² 1/90 m² 7k - 20k m² $1/145 \text{ m}^2$ $>20,000 \text{ m}^2$ 1/168 m² OFFICE: <15% NOTES: 1 driveway setback - 1.5m from lot line 2 If accessory office use and retail net floor areas are 15% or less of the total net floor area: Up to 7,000 m2 - 1 parking space per 90 m2 net floor area or portion thereof 7,000 to 20,000 m2 - 78 parking spaces, plus 1 parking space per 145 m2 of net floor area or portion thereof over Over 20,000 m2 - 168 parking spaces, plus 1 parking space per 170 m2 of net floor area or portion thereof over 3 If associated office or retail net floor areas are more than 15% of the total net In addition to the standards contained above in, the applicable net floor areas exceeding 15% shall be subject to 1 parking space per 30 m2 of net floor area or portion 4 14.0m from a provincial highway. 20m front yard abutting a residential zone. 15m exterior/interior side and rear yards abutting residential 5 3m on one side, 6m on the other 6 18m in MP zone, 12.2m in MS zone NOTE: HEIGHT VARIANCE MAY BE REQUIRED DEPENDING ON ZONING This conceptual design is based upon a preliminary review of entitlement requirements and on unverified and possibly incomplete site and/or building information, and is intended merely to assist in exploring how the project might be developed. Stormwater Management Design: ASSUMED UNDERGROUND SYSTEM Boundary Source: PDF ALTA SURVEY Wellcare Holistic Wellness House

12304 Heart Lake Rd, Kleinburg, ON... SouthFields Village PS 14 Infiniti of Brampton Prism Home Inspections Ross Drive Public Sc Fair Creation NORTH

Conceptual Site Plan

scheme: 09


12304 Heart Lake Road

Caledon, ON, Canada

0 20m 40m 75m



ATTACHMENT 2 – SITE PLAN FOR PHASE 2 DEVELOPMENT

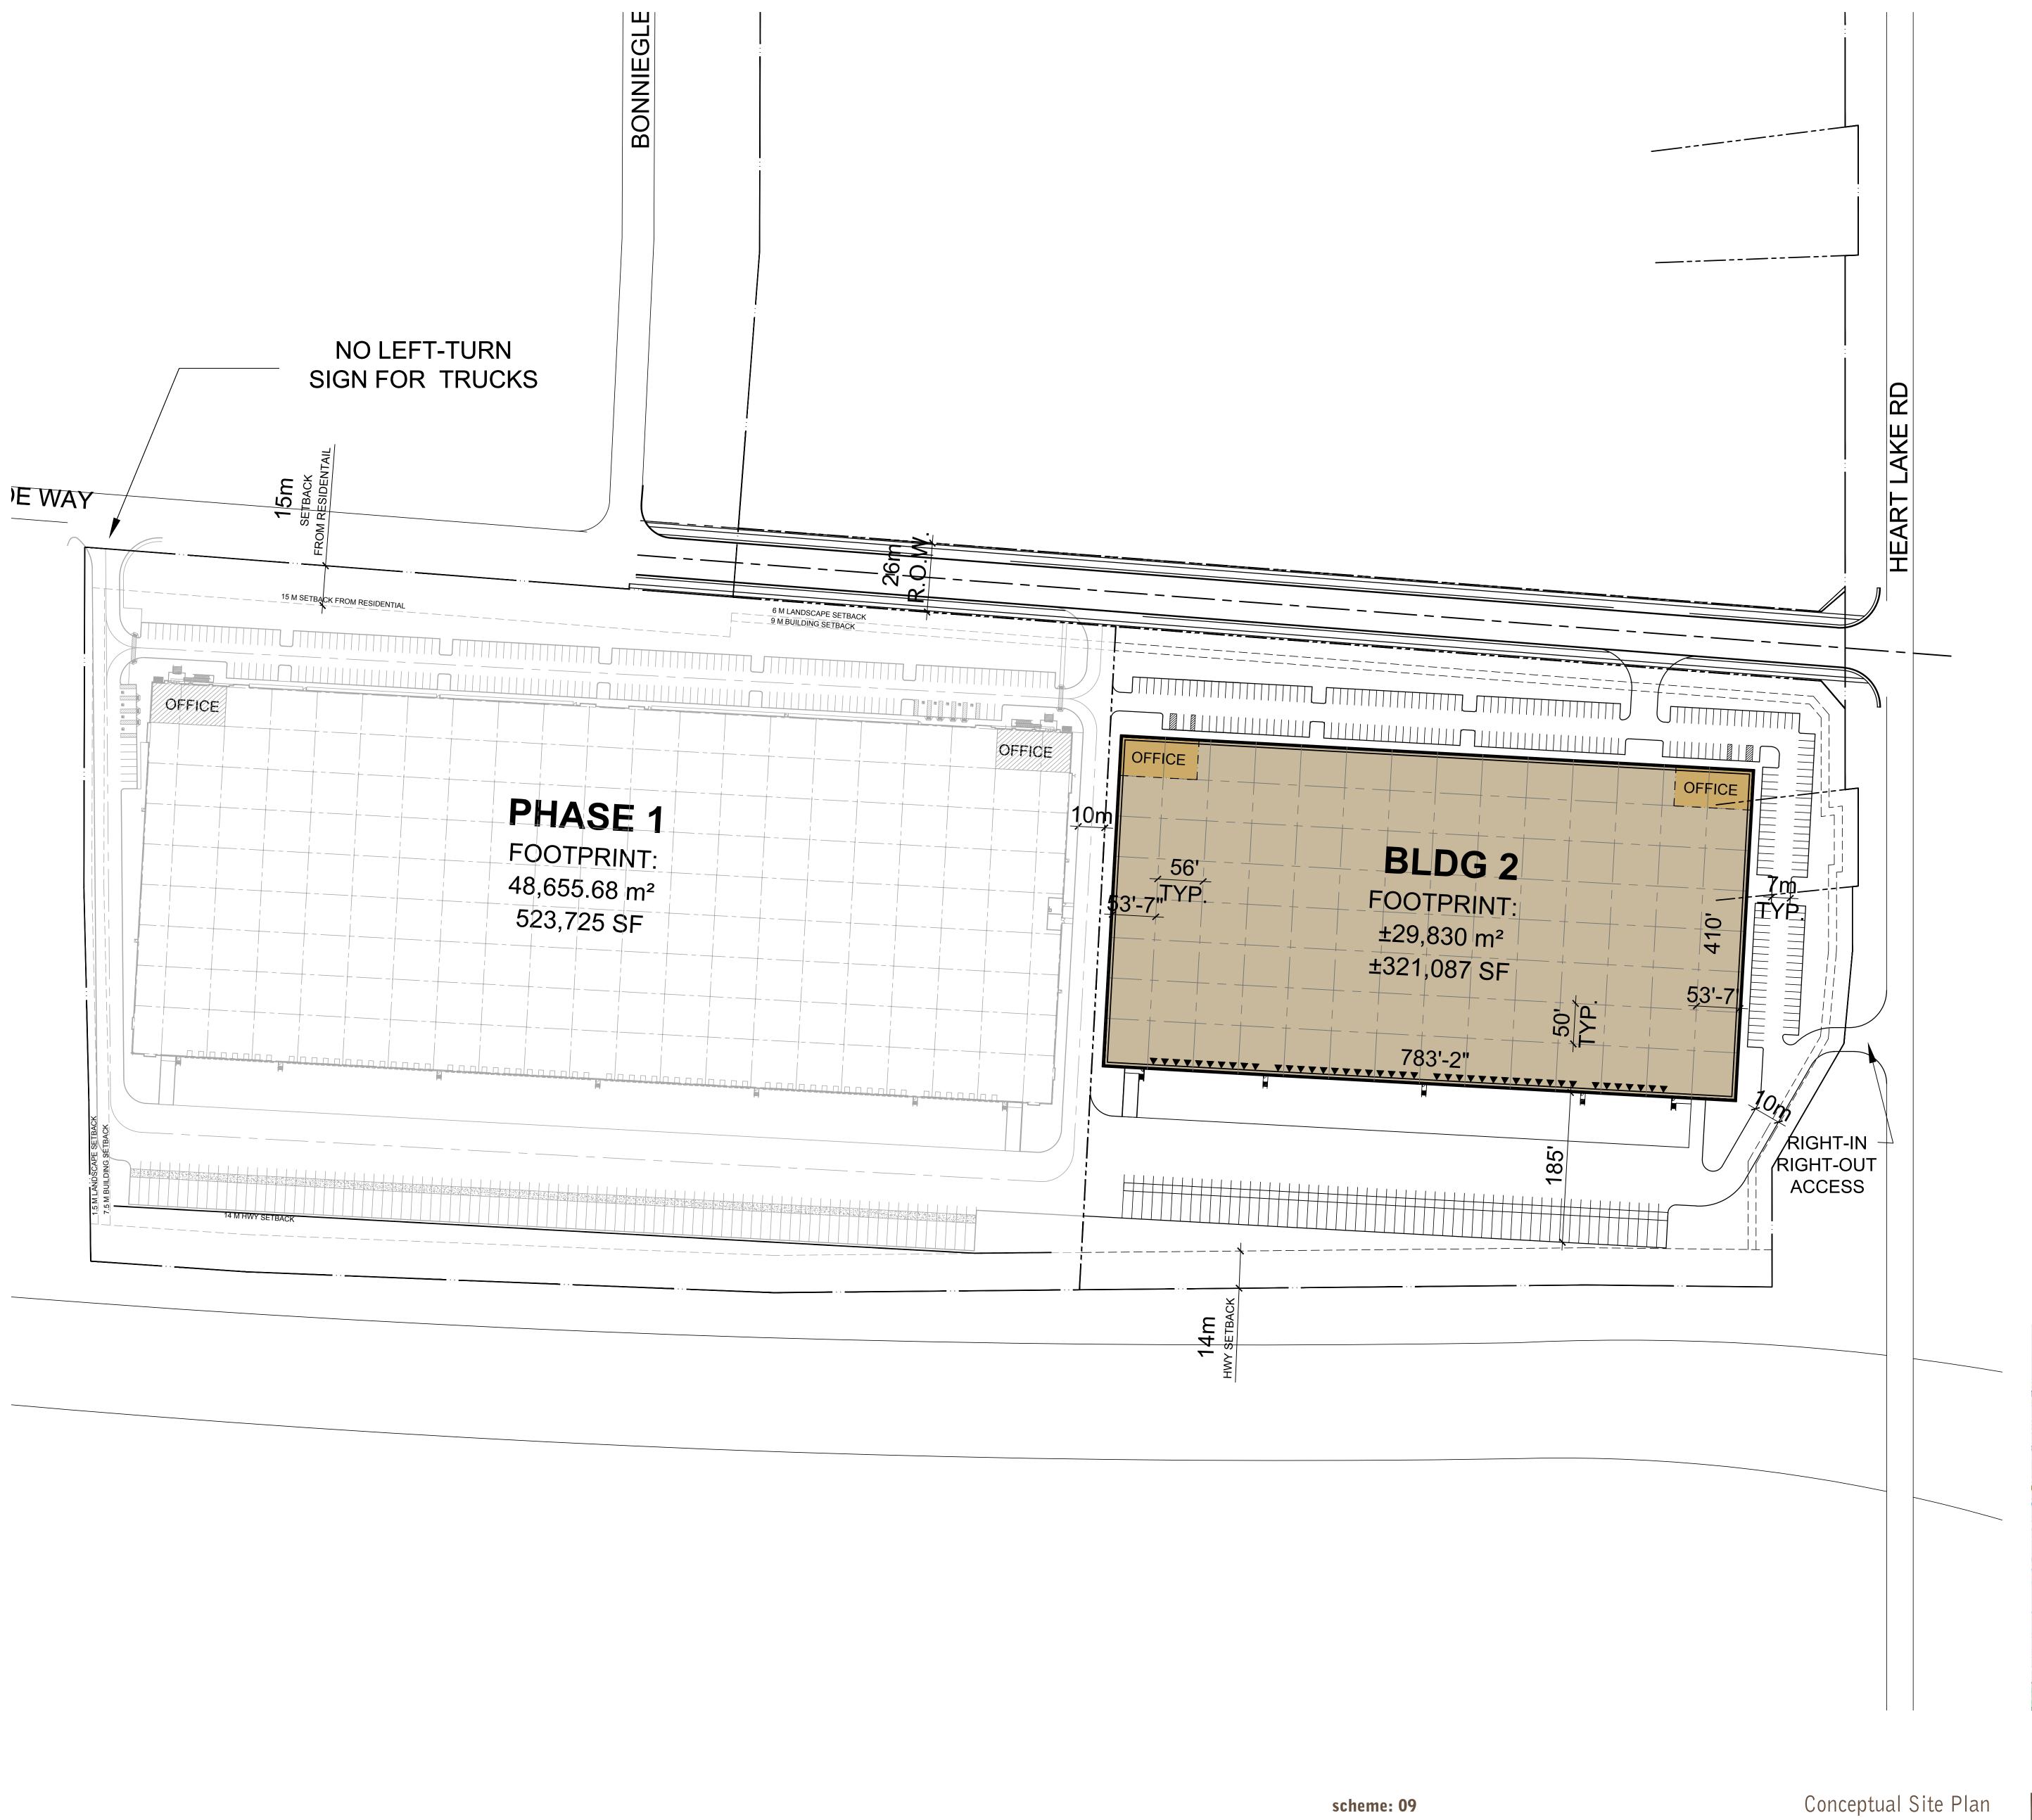

PROJECT DATA: DEVELOPMENT STANDARDS: SITE AREA: ZONING: GROSS: 91.52 AC 37.04 HA MAX. F.A.R.: 3,986,633 SF 370,370 m² MAX. COVERAGE: BUILDING AREA: MAX. HEIGHT: PHASE 1 523,725 SF 48,656 m² BUILDING 2 321,087 SF BUILDING SETBACKS: 844,813 SF TOTAL: 78,486 m² FRONT: FAR: SIDE (INT): GROSS: SIDE (EXT): NET: 0.21 REAR: COVERAGE: GROSS: 21% PARKING SETBACKS: NET: 21% **BUILDING 2** ▲ DOCK-HIGH DOORS SIDE (EXT): • GRADE-LEVEL DOORS REAR: PARKING REQUIRED: DRIVEWAY WAREHOUSE 78 STALLS 7,000 m² $<7k \text{ m}^2$ LANDSCAPE REQ.: 90 STALLS 13,000 m² 7k-20k m² 59 STALLS OFF-STREET PARKING: >20k m² 9,830 m² TOTAL 226 STALLS STANDARD: DRIVE AISLE: PARKING PROVIDED: 226 STALLS REQ. PARKING RATIO BY USE: @0.7/1000 SF @0.76/100 m² WAREHOUSE: REQ. ACCESSIBLE To be confimed by City \leq 7,000 m² TRAILER STALLS 56 STALLS 7k - 20k m² $>20,000 \text{ m}^2$ OFFICE: NOTES: 1 driveway setback - 1.5m from lot line 2 If accessory office use and retail net floor areas are 15% or less of the total net floor area: Up to 7,000 m2 - 1 parking space per 90 m2 net floor area or portion thereof 7,000 to 20,000 m2 - 78 parking spaces, plus 1 parking space per 145 m2 of net floor area or portion thereof over Over 20,000 m2 - 168 parking spaces, plus 1 parking space per 170 m2 of net floor area or portion thereof over 3 If associated office or retail net floor areas are more than 15% of the total net In addition to the standards contained above in, the applicable net floor areas exceeding 15% shall be subject to 1 parking space per 30 m2 of net floor area or portion 4 14.0m from a provincial highway. 20m front yard abutting a residential zone. 15m exterior/interior side and rear yards abutting residential 5 3m on one side, 6m on the other 6 18m in MP zone, 12.2m in MS zone NOTE: HEIGHT VARIANCE MAY BE REQUIRED DEPENDING ON ZONING

This conceptual design is based upon a preliminary review of entitlement requirements and on unverified and possibly incomplete site and/or building information, and is intended merely to assist in exploring how the project might be developed.

MP/MS

0.50

50%

9 m

3m, 6m

7.5 m

7.5 m

3 m

3 m

3 m

1.5m

10%

6 m

2.75X6.0

1/90 m²

 $1/145 \text{ m}^2$


1/168 m²

<15%

12.2 m

Stormwater Management Design: ASSUMED UNDERGROUND SYSTEM


Boundary Source: PDF ALTA SURVEY

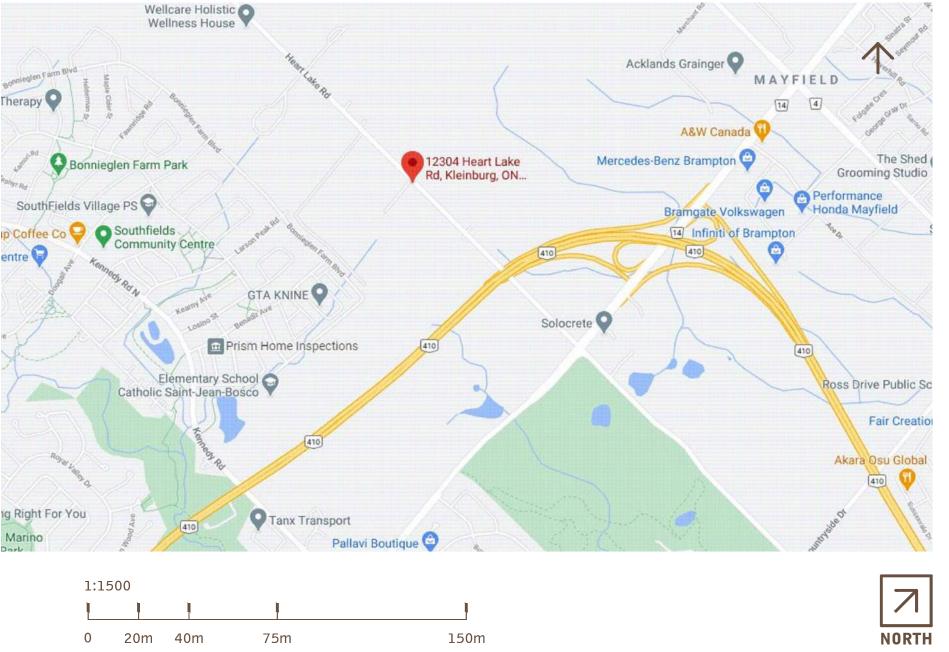


0 20m 40m



ATTACHMENT 3 – LANDSCAPE PLAN FOR PHASE 1

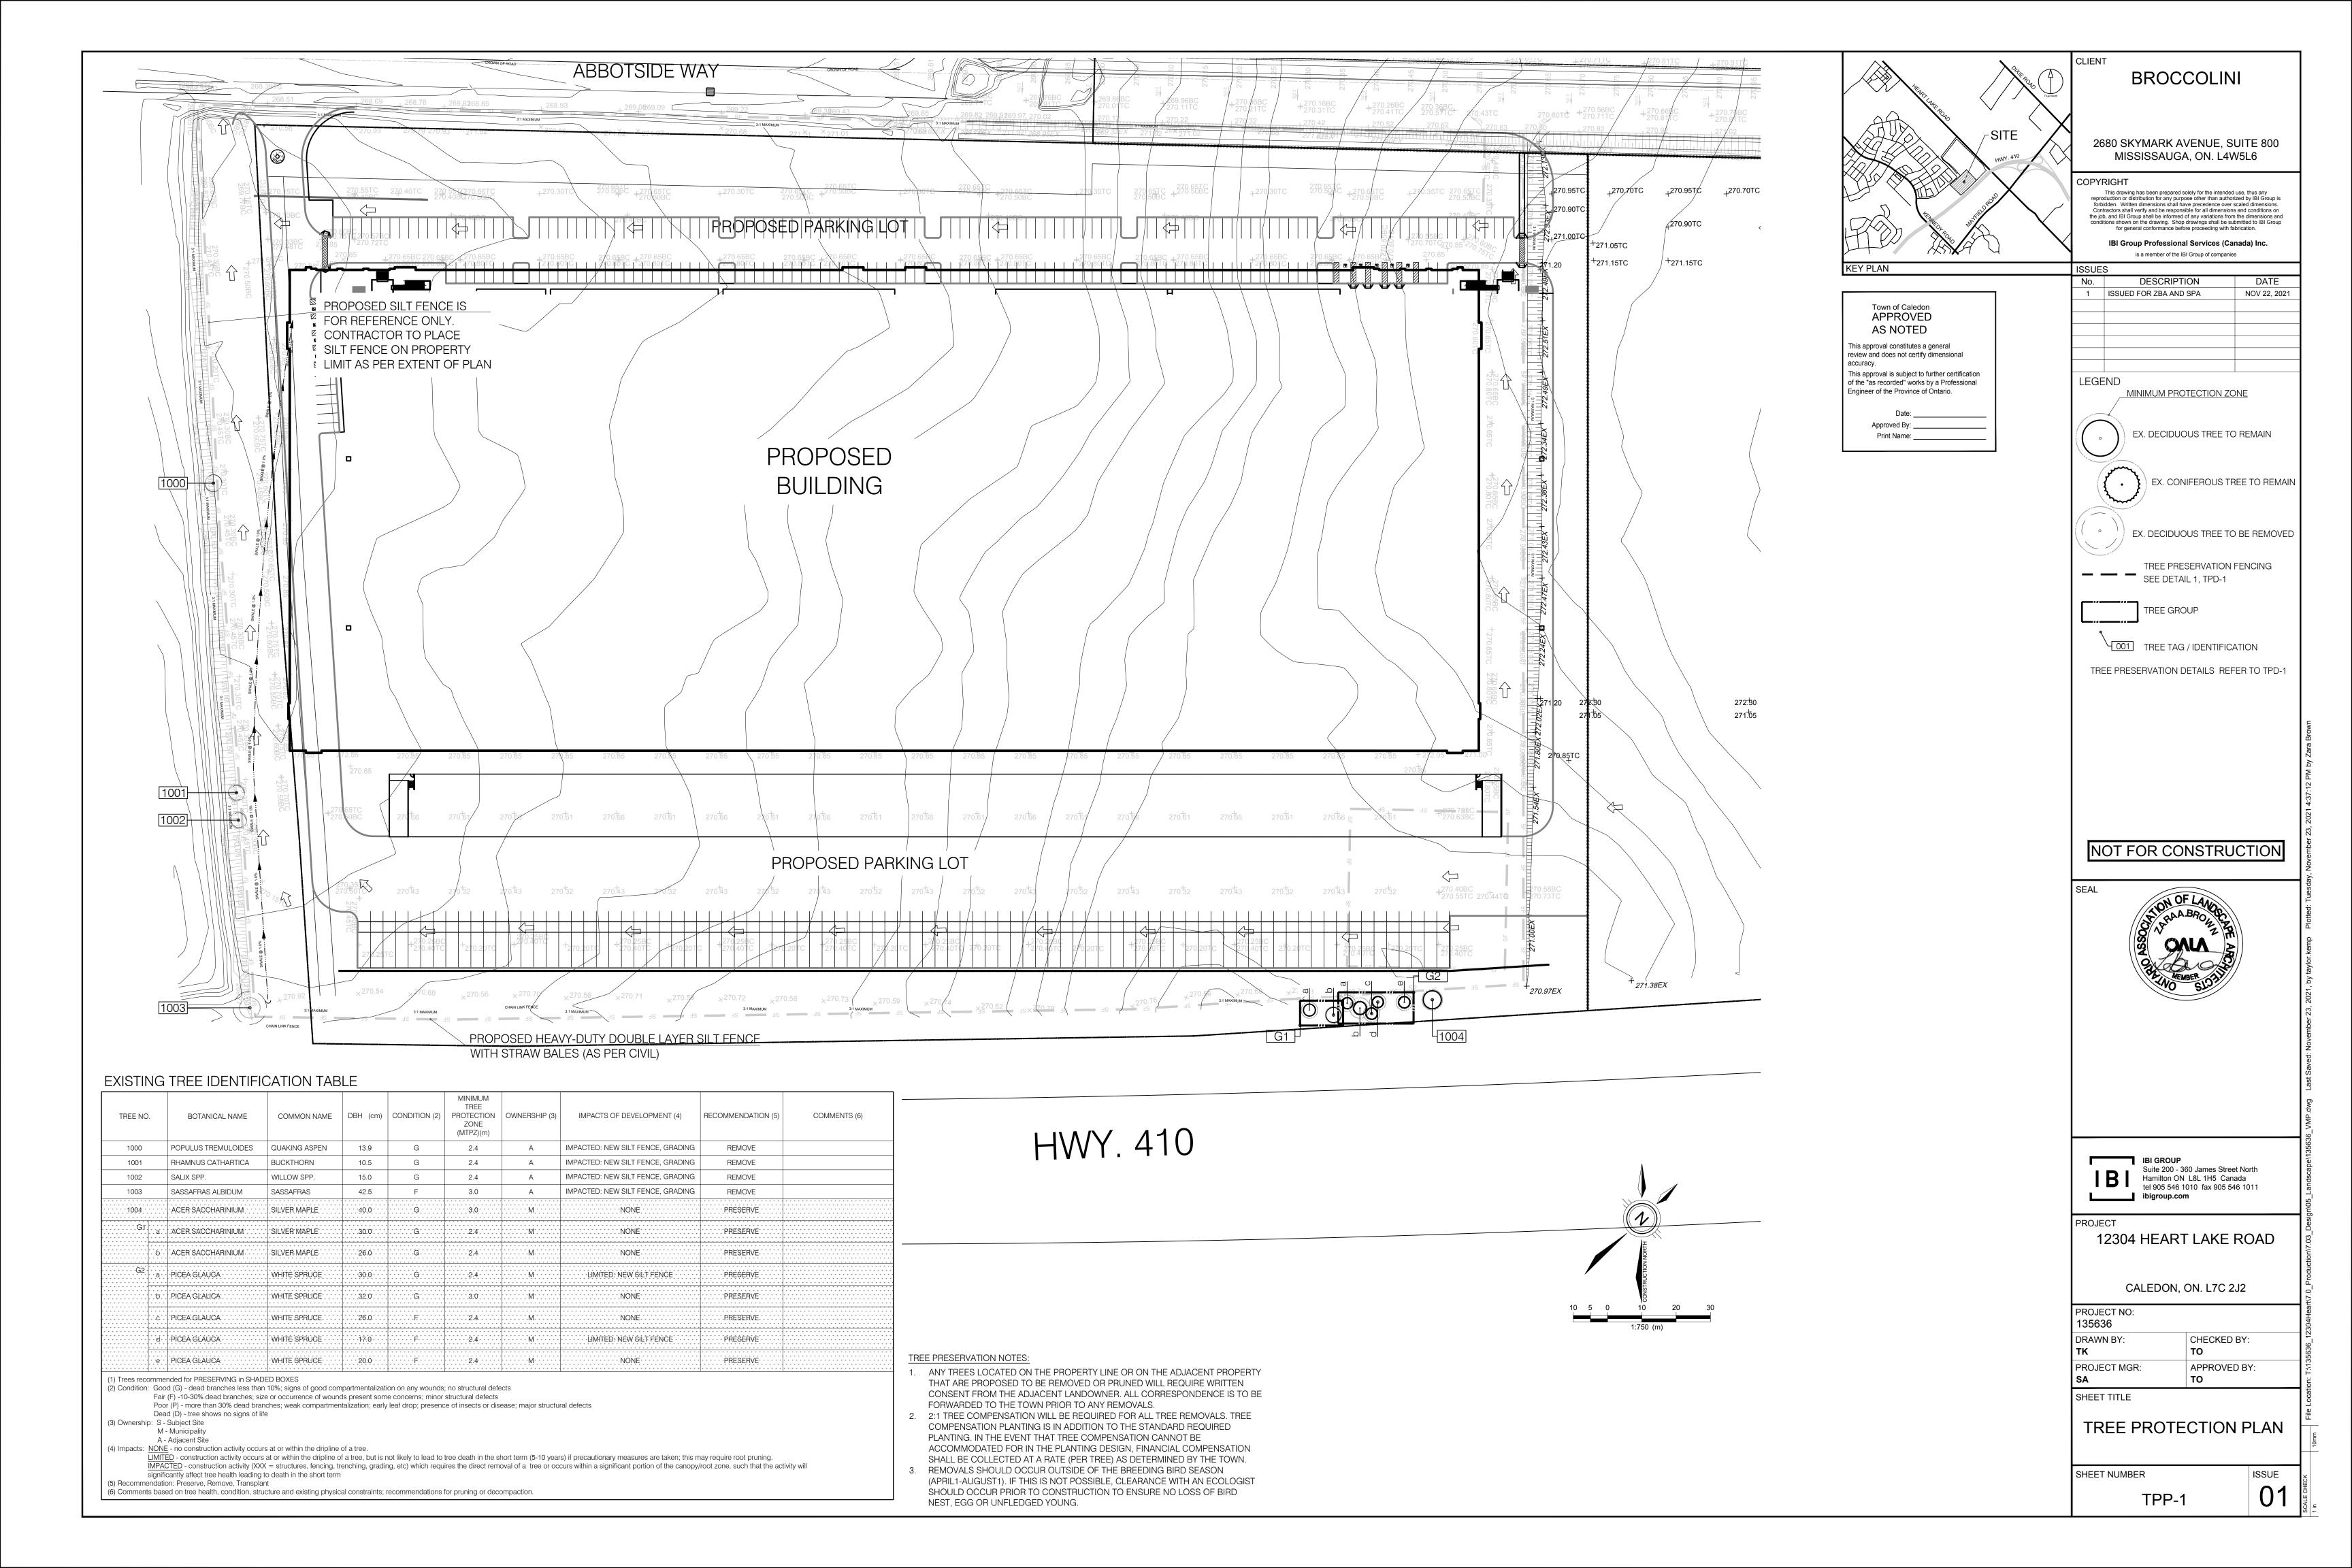

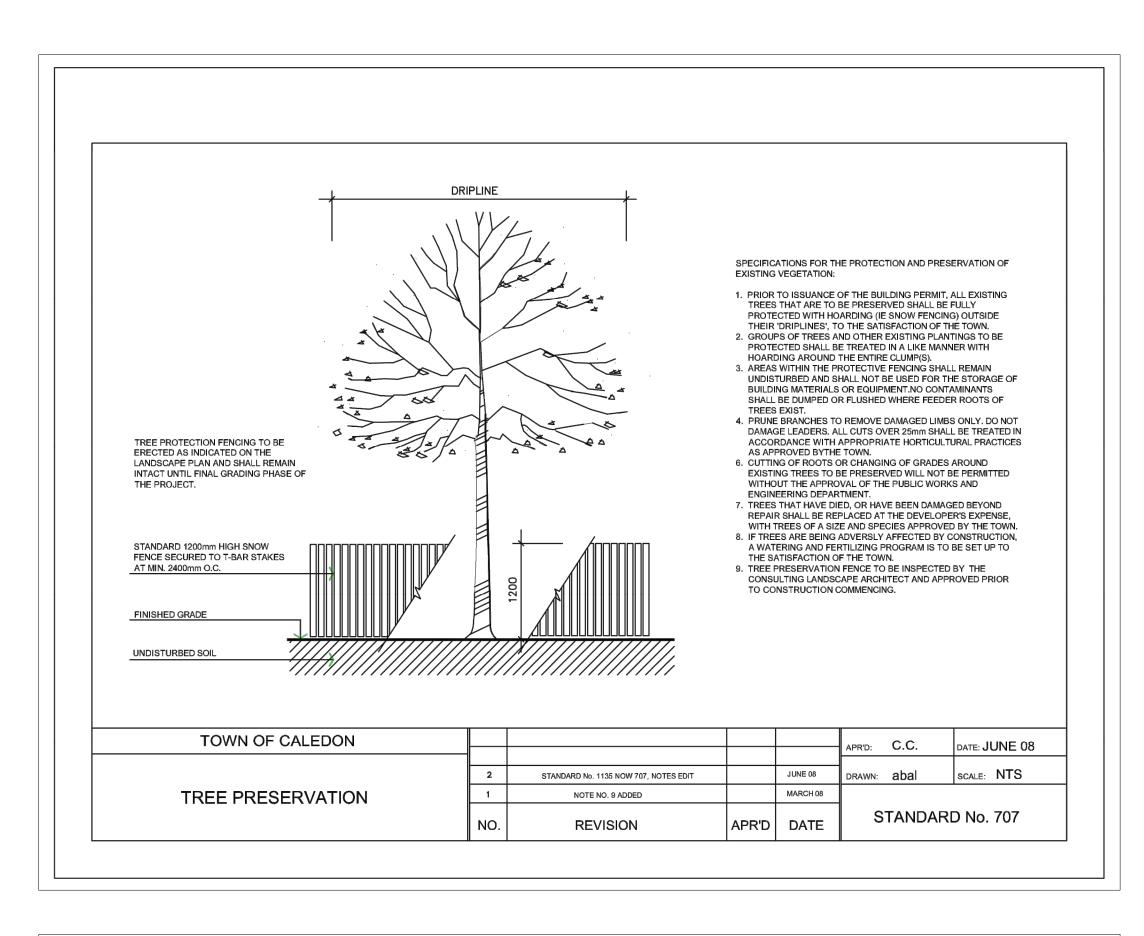

SPECIFICATIONS

The following Tree Preservation and Protection Measures will be undertaken to help eliminate and/or significantly reduce construction injury to all trees recommended for preservation. All temporary tree protection measures cited for retained trees must comply with the Town of Caledon Tree Protection Specifications and Details. Any variation from the standard tree protection measures must be approved in writing by the Town of Caledon.

B. <u>Pre-Construction Phase</u>

- Prior to construction, the trees to be preserved shall be protected with a Tree Protection Barrier. The barrier shall consist of 1.2m (4ft) high orange plastic snow fence wired to T-bars (see Town of Caledon Tree Preservation Fencing, STD 606).
- 2. If applicable, attach a filter cloth 600mm high to the construction side of the hoarding to act as sediment control. Sediment control fencing shall meet or exceed OPSD-219.110, and be installed to the satisfaction of the Town of Caledon.
- 3. All supports and bracing used to safely secure the barrier should be located outside the Tree Protection Zone (TPZ). All supports and
- bracing should minimize damage to roots. 4. The TPZ fence is to be installed along the edge of the tree protection zones. This hoarding is to remain in place and remain in good condition throughout the entire duration of the project. Dismantling the tree protection barrier prior to approval by the Town of Caledon staff
- may constitute a contravention. 5. The applicant shall notify the Town of Caledon and the consulting certified arborist or landscape architect to confirm that the tree protection barriers are in place.

- 6. Where fill or excavated material must be temporarily located near a TPZ, a wooden barrier must be used to ensure no material enters the
- 7. Remove any garbage and foreign debris from the tree protection zones, daily.
- 8. For the trees that were recommended for removal and/or crown pruning that are within the TPZ limits, these activities are to be performed by a qualified ISA certified arborist prior to the installation of the Tree Protection Zone barriers and prior to the commencement of any construction activities. Install the Tree Protection Zone barrier as per Tree Preservation Fencing, STD 606 at the limits shown on the tree inventory and protection plan after the tree removal, whichever is greater, and crown pruning activities are completed.
- 9. A Tree Protection Zone sign must be mounted on all sides of the tree protection barrier for the duration of site construction. The sign should be a minimum of 40cm x 60cm and made of white gator board or equivalent material.
- 10. The sign must be similar to the illustration shown below, or as directed by the Town of Caledon.

TREE PROTECTION ZONE No work is permitted in the Tree Protection Zone This includes construction works, grading, storage of trash or materials. The tree protection barrier must not be removed without written

authorization of the Town of Caledon.

11. All contractors and site visitors should be informed of the tree preservation and protection measures at a pre-construction meeting.

specifications continued on next panel...

TOWN OF CALEDON					APR'D:	B.B.	DATE: AUGUST
TREE PRESERVATION					DRAWN:	B.M.	SCALE: NTS
							•
STANDARD NOTES - PART 1	NO.	REVISION	APR'D	DATE	S	STANDAR	D No. 710

SPECIFICATIONS continued from previous panel

C. <u>During Construction Phase</u>


- 1. All areas within the TPZ shall remain undisturbed for the duration of construction. There will be no grade changes, dumping, and storage of any materials, structures or equipment within these areas. The Tree Protection Barrier must not be removed without the written authorization of the Town of
- 2. Minor grading works will be permitted at the edge of the preservation zone as required to correct localized depressions, and blend to existing grades. This work to be undertaken under the direct supervision of an ISA certified arborist. 3. A certified ISA arborist will undertake proper root pruning in accordance with
- acceptable arboriculture practices when and if roots of retained trees are to be exposed, damaged, or severed by construction work. The exposed roots will be backfilled with appropriate material as soon as possible to prevent desiccation. Root pruning prior to excavation will help prevent necessary damage to tree roots. The use of low pressure hydrovac to expose roots is recommended, at no additional cost.
- 4. The Town of Caledon must be notified for all work that impacts the TPZ for temporary removal of a section of hoarding to gain access for fine grading or other works. All works are to be supervised by the Town of Caledon.
- 5. No cables, wire or ropes of any kind shall be wrapped around or installed in trees to be preserved.
- 6. No contaminants will be dumped or flushed in the TPZ areas or where feeder roots of trees exist (generally beyond the TPZ areas).
- 7. Irrigate tree protection zones during drought conditions, June to September to reduce drought stress.
- 8. Inspect the site daily to ensure hoarding is in place and in good condition. Inspect trees to monitor condition.

Post Construction Phase

- 1. Following the completion of all site works including landscaping, and after review and approval by the Town of Caledon staff, the protective hoarding
- After removal of the protective hoarding, the Tree Preservation Zones shall be inspected by the Town of Caledon staff. Any remaining dead, diseased, or hazardous limbs or trees are to be removed by an ISA certified arborist as directed by the consulting arborist or Town of Caledon staff.

end of specifications

TOWN OF CALEDON					APR'D:	B.B.	DATE: AUGUST 17
TREE PRESERVATION					DRAWN:	B.M.	scale: NTS
+							
STANDARD NOTES - PART 2	NO.	REVISION	APR'D	DATE	S	TANDAR	D No. 711

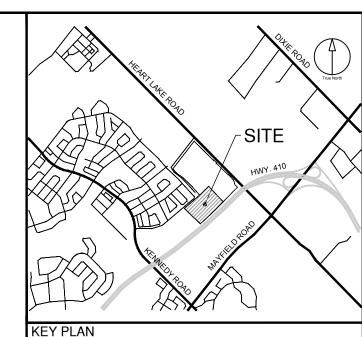

Print Name: _

BROCCOLINI

2680 SKYMARK AVENUE, SUITE 800 MISSISSAUGA, ON. L4W5L6


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This drawing has been prepared solely for the intended use, thus any reproduction or distribution for any purpose other than authorized by IBI Group is forbidden. Written dimensions shall have precedence over scaled dimensions. Contractors shall verify and be responsible for all dimensions and conditions on the job, and IBI Group shall be informed of any variations from the dimensions and conditions shown on the drawing. Shop drawings shall be submitted to IBI Group for general conformance before proceeding with fabrication.

IBI Group Professional Services (Canada) Inc. is a member of the IBI Group of companies

ISSUES DESCRIPTION DATE ISSUED FOR ZBA AND SPA NOV 22, 2021 Town of Caledon APPROVED AS NOTED This approval constitutes a general review and does not certify dimensional This approval is subject to further certification LEGEND of the "as recorded" works by a Professional Engineer of the Province of Ontario.

NOT FOR CONSTRUCTION

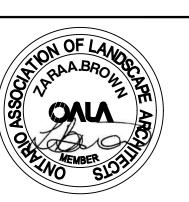

IBI GROUP Suite 200 - 360 James Street North Hamilton ON L8L 1H5 Canada tel 905 546 1010 fax 905 546 1011 ibigroup.com

PROJECT

12304 HEART LAKE ROAD

CALEDON, ON. L7C 2J2


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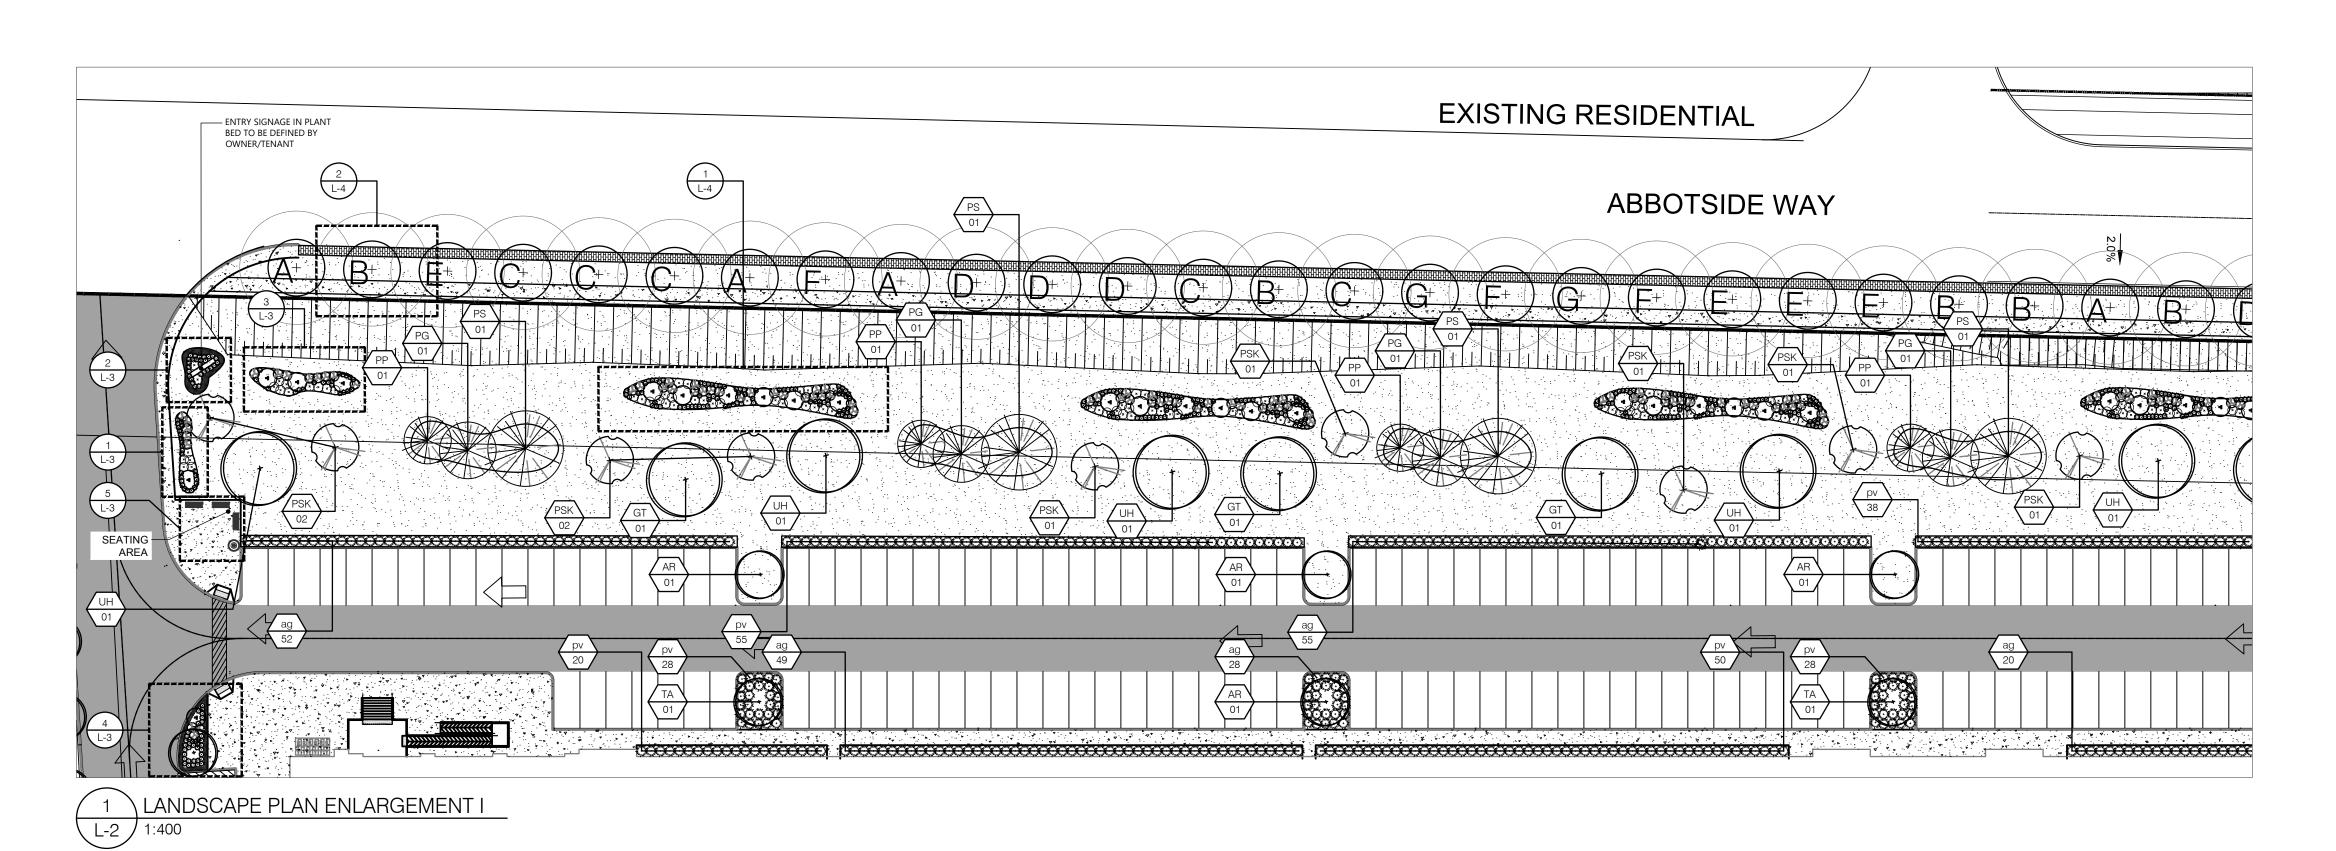
SHEET TITLE


TREE PROTECTION DETAILS

SHEET NUMBER

ISSUE




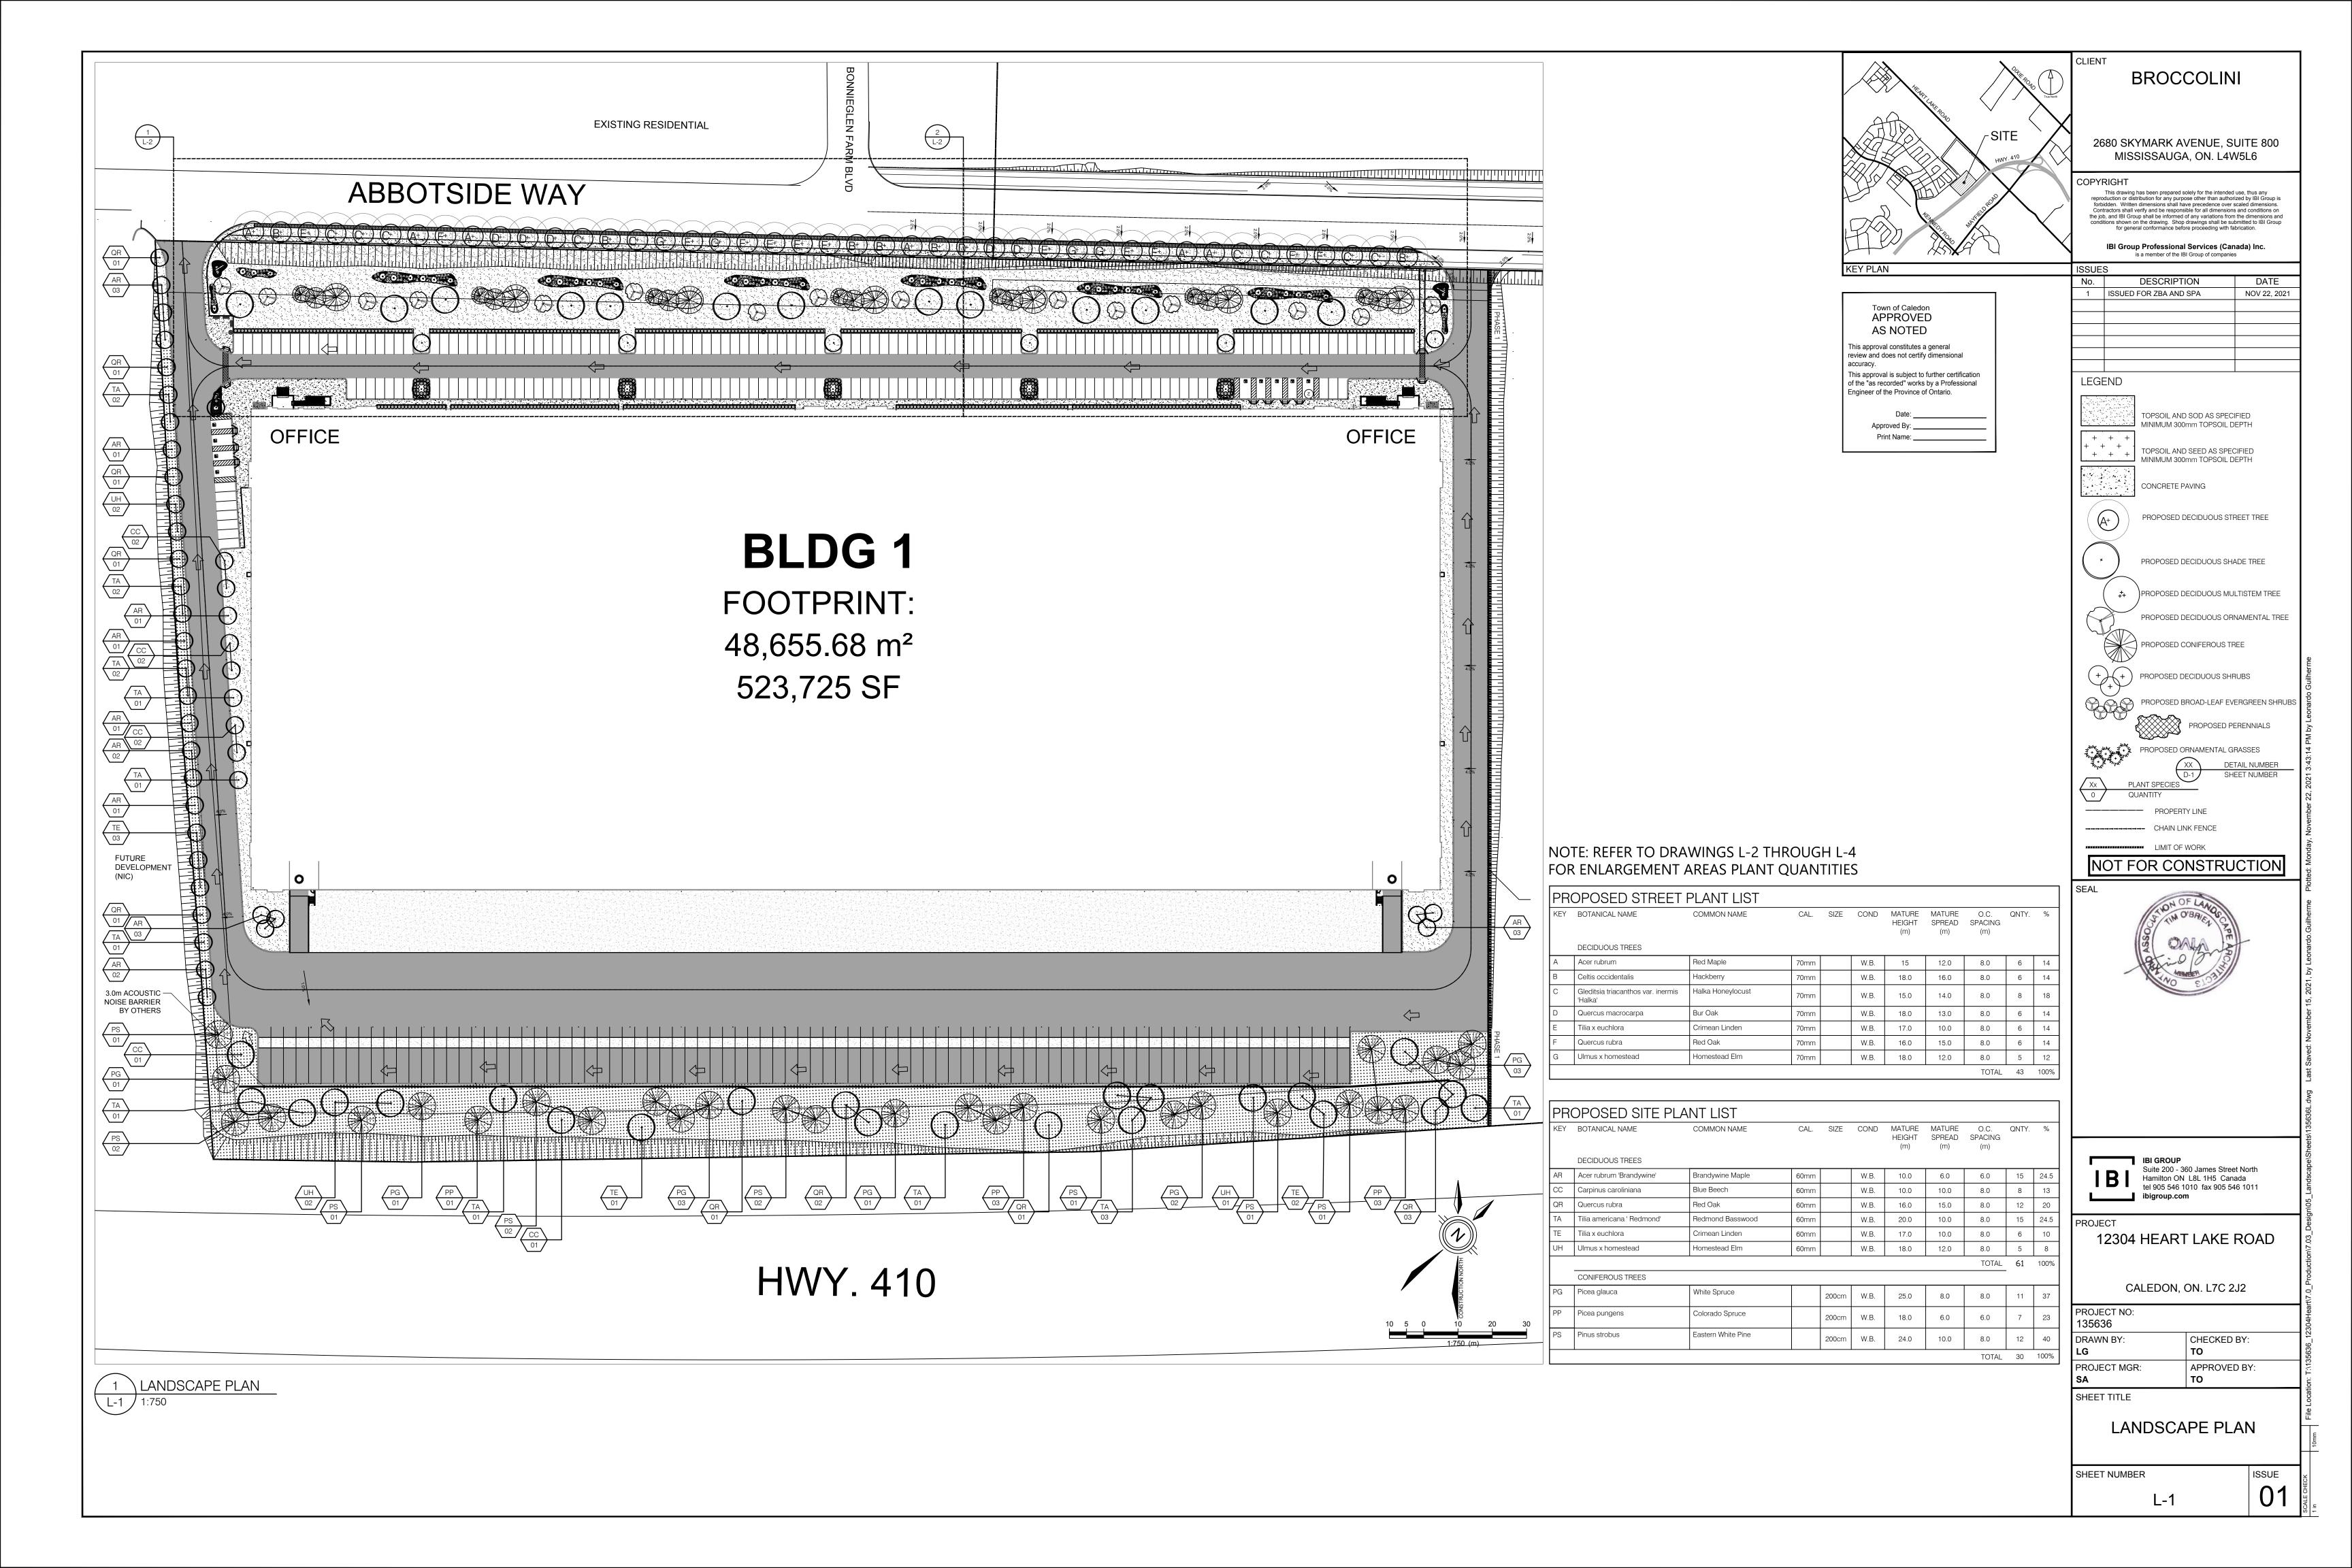

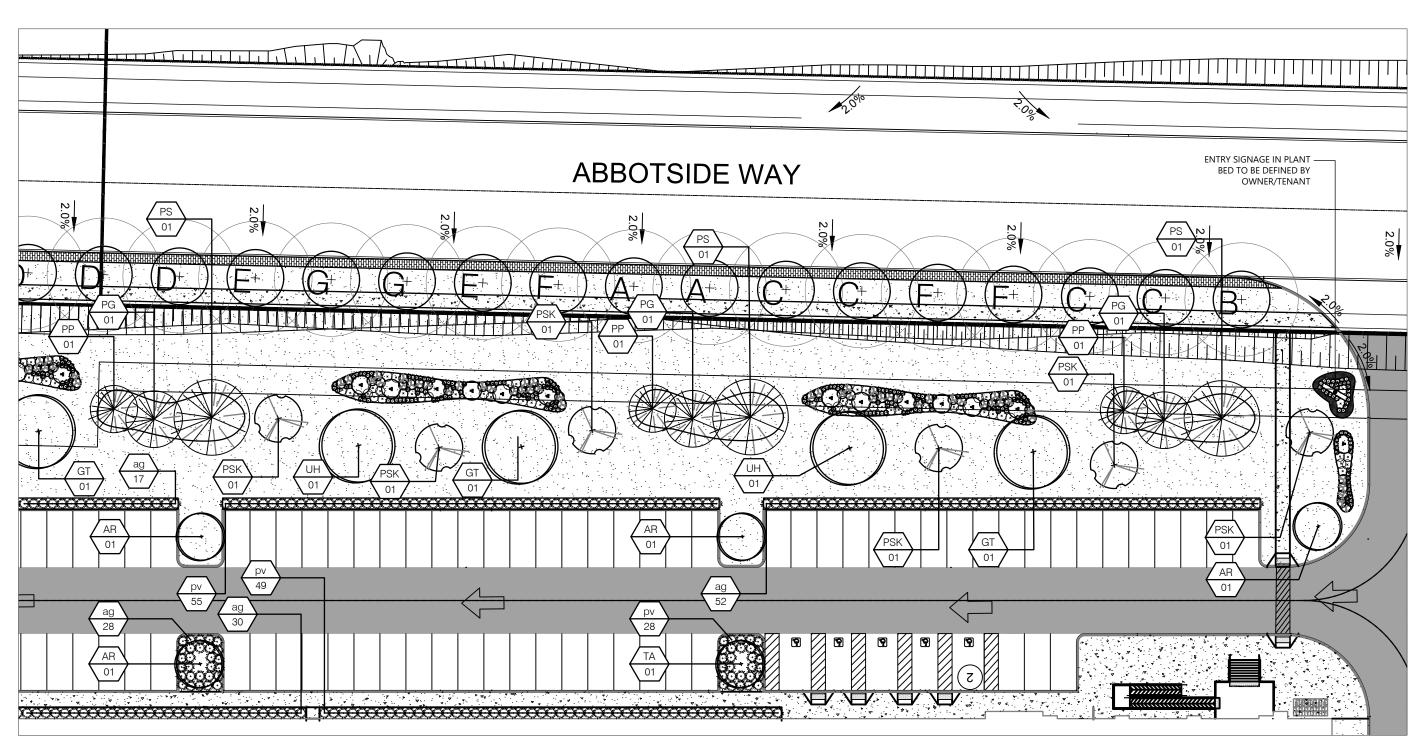

KEY	BOTANICAL NAME	COMMON NAME	CAL.	SIZE	COND	MATURE HEIGHT (m)	MATURE SPREAD (m)	O.C. SPACING (m)	QNTY.	%
	DECIDUOUS TREES									
AR	Acer rubrum 'Brandywine'	Brandywine Maple	60mm		W.B.	10.0	6.0	6.0	8	
GT	Gleditsia triacanthos var. inermis	Thornless Honeylocust	60mm		W.B.	18.0	13.0	6.0	6	
PSK	Prunus serrulata 'Kwanzan'	Kwanzan Flowering Cherry	60mm		W.B.	10.0	6.0	6.0	15	
TA	Tilia americana ' Redmond'	Redmond Basswood	60mm		W.B.	20.0	10.0	8.0	3	
UH	Ulmus x homestead	Homestead Elm	60mm		W.B.	18.0	12.0	8.0	7	
								TOTAL	39	
	CONIFEROUS TREES									
PG	Picea glauca	White Spruce		200cm	W.B.	25.0	8.0		7	
					W.B.	24.0	10.0		_	
PS	Pinus strobus	Eastern White Pine		200cm	VV.D.	24.0	10.0		7	
	Pinus strobus Picea pungens	Eastern White Pine Colorado Spruce		200cm 200cm	W.B.	18.0	6.0		7	
PS PP								TOTAL	'	
								TOTAL	7	
	Picea pungens							TOTAL	7	

\ LANDSCAPE PLAN ENLARGEMENT II L-2 / 1:400

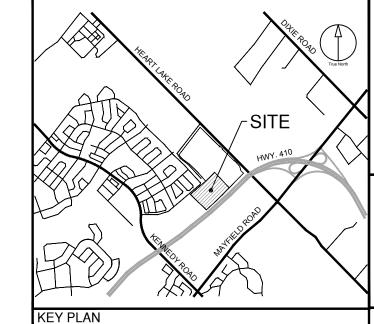

BROCCOLINI

2680 SKYMARK AVENUE, SUITE 800 MISSISSAUGA, ON. L4W5L6

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Town of Caledon APPROVED AS NOTED This approval constitutes a general review and does not certify dimensional This approval is subject to further certification of the "as recorded" works by a Professional Engineer of the Province of Ontario. Approved By: _____ Print Name: _____

ISSUE	S								
No.	DESCRIPTION	DATE							
1	ISSUED FOR ZBA AND SPA	NOV 22, 2021							
LEGI	LEGEND								
34, 34	[No. 28.2.84.84.8]								

TOPSOIL AND SOD AS SPECIFIED MINIMUM 300mm TOPSOIL DEPTH

CONCRETE PAVING

PROPOSED DECIDUOUS STREET TREE

+ PROPOSED DECIDUOUS MULTISTEM TREE PROPOSED DECIDUOUS ORNAMENTAL TREE PROPOSED CONIFEROUS TREE

PROPOSED DECIDUOUS SHRUBS

PROPOSED DECIDUOUS SHADE TREE

PROPOSED BROAD-LEAF EVERGREEN SHRUBS

PROPOSED PERENNIALS PROPOSED ORNAMENTAL GRASSES

QUANTITY

NOT FOR CONSTRUCTION



IBI GROUP Suite 200 - 360 James Street North Hamilton ON L8L 1H5 Canada tel 905 546 1010 fax 905 546 1011 ibigroup.com

12304 HEART LAKE ROAD


CALEDON, ON. L7C 2J2

PROJECT NO: 135636	
DRAWN BY: LG	CHECKED BY:
PROJECT MGR: SA	APPROVED BY:


SHEET TITLE

LANDSCAPE PLAN


SHEET NUMBER

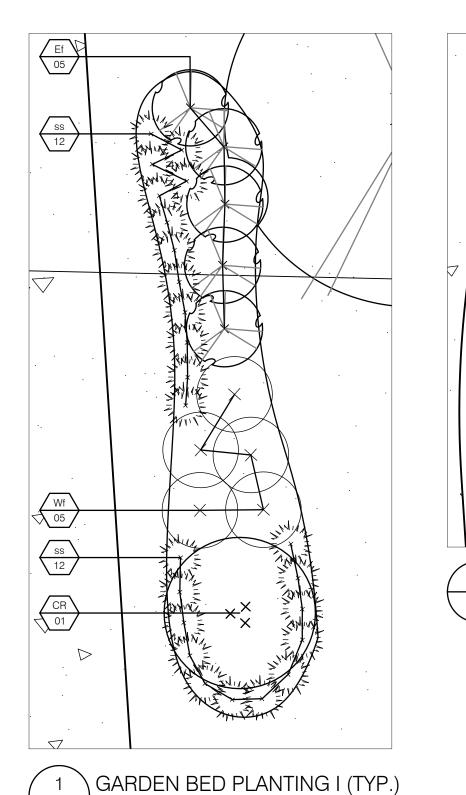


L-3 1:50

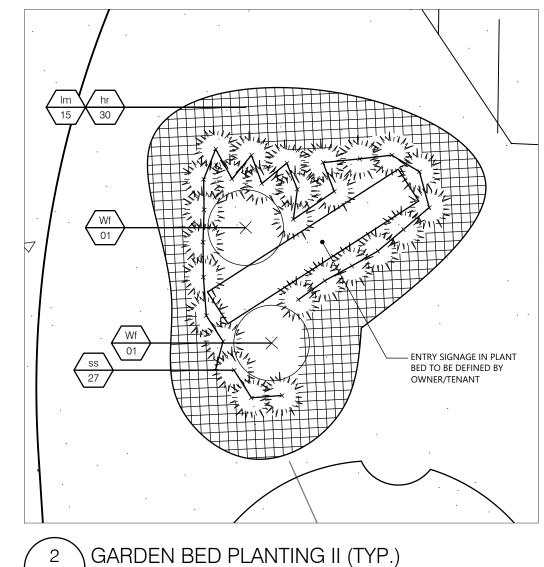

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Print Name: ____

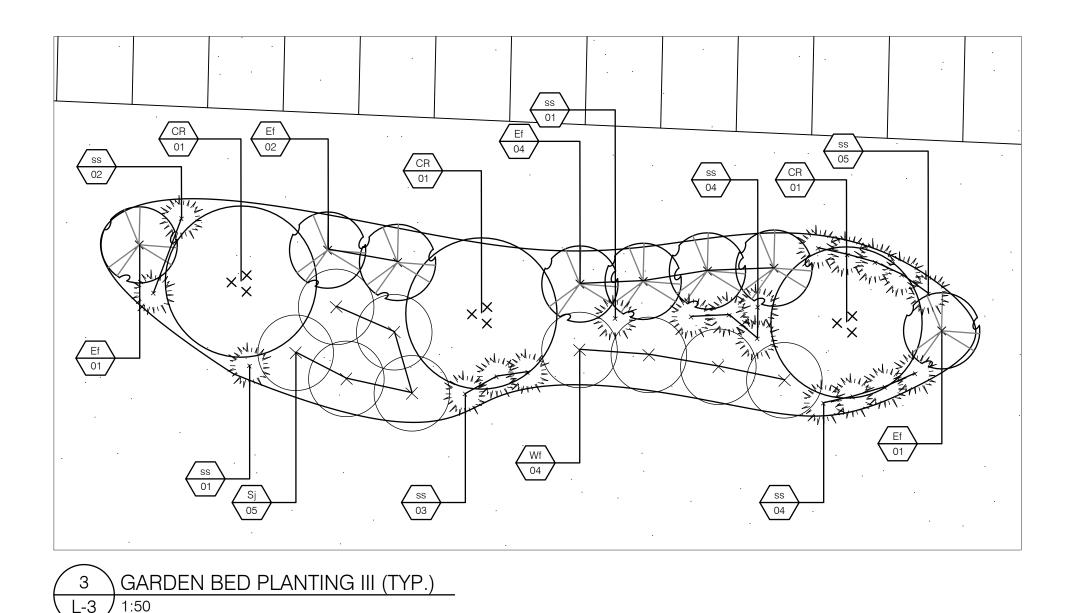200 SERIES

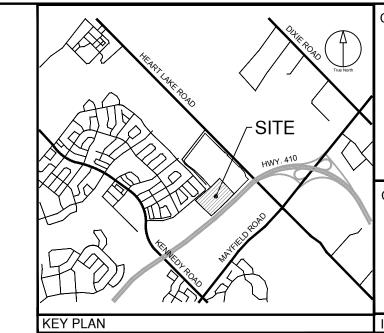WEIGHT: 194.5lbs (88.2kg)

T 800 716 5506 F 877 260 9393 www.maglin.com sales@maglin.com

BROCCOLINI

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DATE

NOV 22, 2021

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ISSUES Town of Caledon APPROVED AS NOTED This approval constitutes a general review and does not certify dimensional This approval is subject to further certification LEGEND of the "as recorded" works by a Professional Engineer of the Province of Ontario.

DESCRIPTION ISSUED FOR ZBA AND SPA TOPSOIL AND SOD AS SPECIFIED

MINIMUM 300mm TOPSOIL DEPTH CONCRETE PAVING

PROPOSED DECIDUOUS SHADE TREE → PROPOSED DECIDUOUS MULTISTEM TREE

→ PROPOSED DECIDUOUS MULTISTEM TREE

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→ PROPOSED MULTISTEM TREE

→

PROPOSED DECIDUOUS SHRUBS

PROPOSED DECIDUOUS ORNAMENTAL TREE

PROPOSED BROAD-LEAF EVERGREEN SHRUBS

PROPOSED PERENNIALS

PROPOSED ORNAMENTAL GRASSES

NOT FOR CONSTRUCTION

SEAL



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PROJECT 12304 HEART LAKE ROAD

ibigroup.com

CALEDON, ON. L7C 2J2

PROJECT NO: 135636 DRAWN BY: CHECKED BY:

PROJECT MGR:

SHEET TITLE


LANDSCAPE PLAN


TO

APPROVED BY:

SHEET NUMBER

1190mm BENCH BY MAGLIN -SEE DETAIL 6/L-3 abla . ablaTRASH RECEPTACLE BY MAGLIN — SEE DETAIL 7/L-3

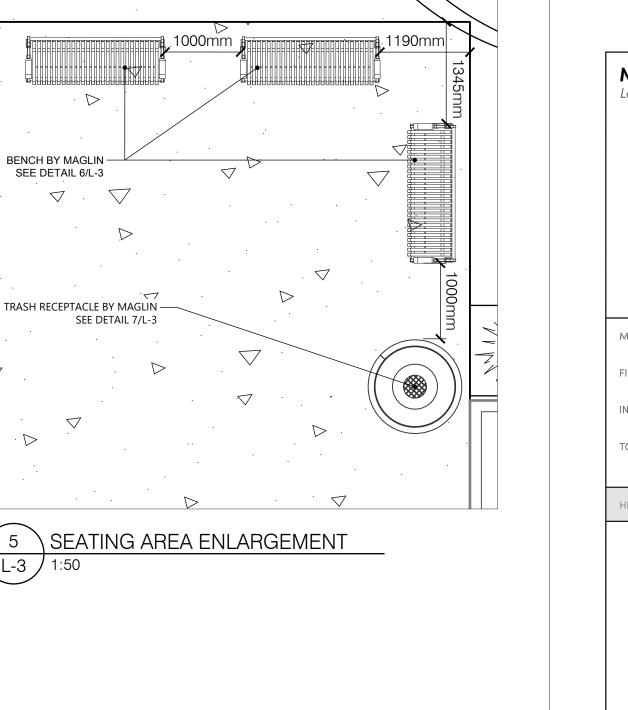

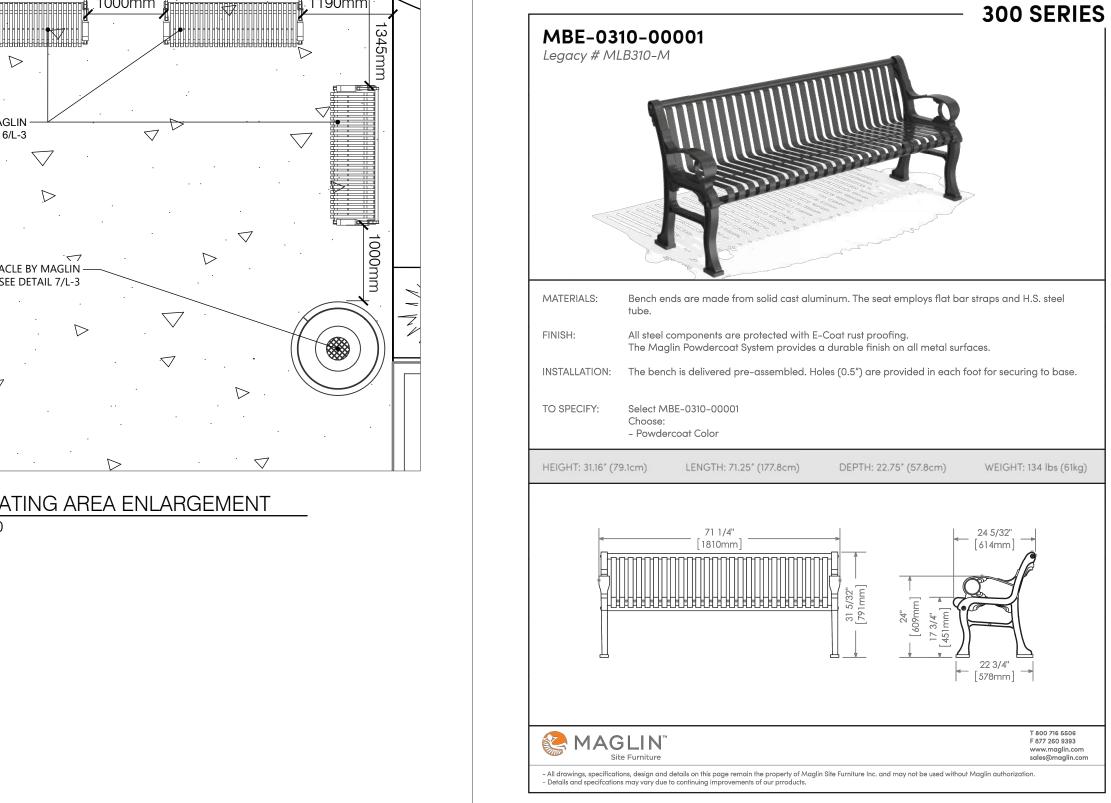



KEY	BOTANICAL NAME	COMMON NAME	CAL.	SIZE	COND	MATURE HEIGHT (m)	MATURE SPREAD (m)	O.C. SPACING (m)	QNTY.	%
	DECIDUOUS TREES									
AR	Acer rubrum 'Brandywine'	Brandywine Maple	60mm		W.B.	10.0	6.0	6.0	1	
CR	Cornus racemosa	Gray Dogwood	Clump	200cm	W.B.	10.0	10.0	10.0	9	
		,	,					TOTAL	10	
	SHRUBS									
Ef	Euonymus fortunei 'Sarcoxie'	Sarcoxie Euonymus		50cm	5 gal	1.3	1.3	1.0	29	
Sj	Spiraea japonica 'Goldflame'	Goldflame Spirea		40cm	3 gal	1.0	1.3	1.0	10	
Wf	Weigela florida 'Rumba'	Rumba Weigela		40cm	3 gal	1.0	1.3	1.0	22	
			•				•	TOTAL	61	
	PERENNIALS / GRASSES									
hr	Hemerocallis 'Rocket City'	Rocket City Daylily			1 gal	0.9	0.6		90	
lm	Liriope muscari 'Big Blue'	Giant Lily Turf			1 gal	0.5	0.4		30	
SS	Schizachyrium scoparium	Little Bluestem			1 gal	1.3	0.7		179	
			'					l		

GARDEN BED PLANTING IV



1 x 32 Gallon Polyethylene Liner

securing to base.

Select MTR-0250-00001

- Powdercoat Color

TO SPECIFY:

HEIGHT: 35 1/2" (90cm)

DESCRIPTION: 200 Series - 250 Trash Receptacle: Heavy Duty Steel Flat Bar and H.S. Steel Frame, Bottles/Cans Lid,


All steel components are protected with E-Coat rust proofing. The Maglin Powdercoat System provides a durable finish on all metal surfaces.


INSTALLATION: The trash container is delivered pre-assembled. Holes (0.5") are provided in each mounting foot for

DIAMETER: 24 5/8" (62.5cm)

MTR-0250-00001


Legacy # MLWR250-32-BC

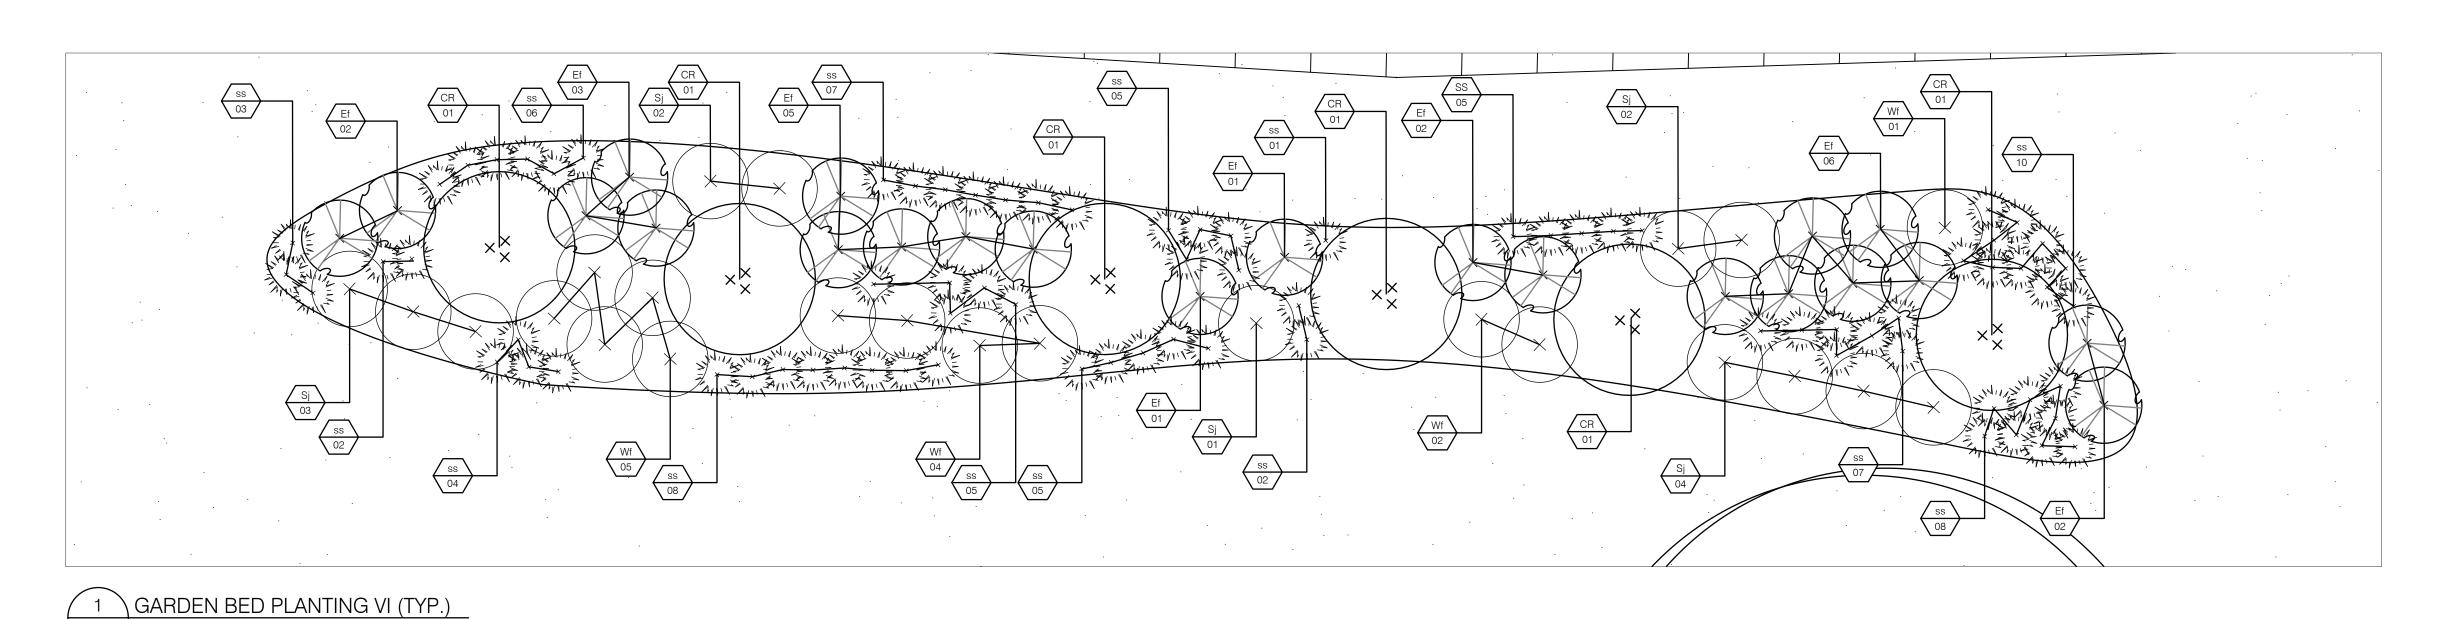

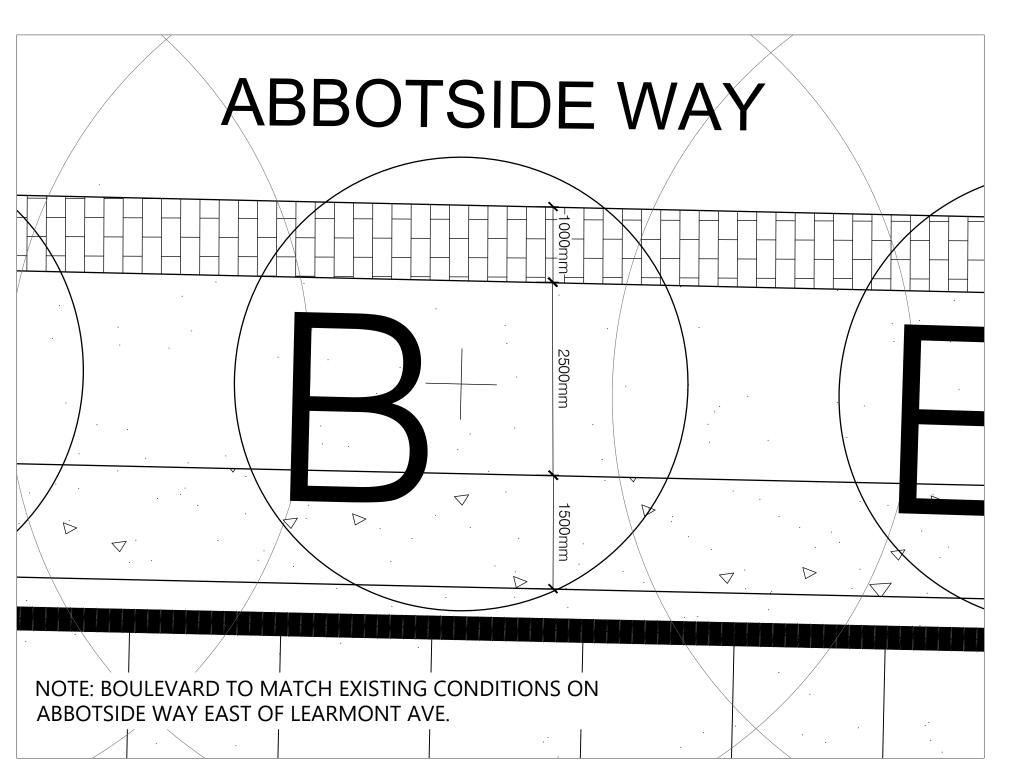

2 BOULEVARD DETAIL

KEY	BOTANICAL NAME	COMMON NAME	CAL.	SIZE	COND	MATURE HEIGHT (m)	MATURE SPREAD (m)	O.C. SPACING (m)	QNTY.	%
	DECIDUOUS TREES									
CR	Cornus racemosa	Gray Dogwood	Clump	200cm	W.B.	10.0	10.0	10.0	36	
		•	<u>'</u>			•	•	TOTAL	36	
	SHRUBS									
Ef	Euonymus fortunei ' Sarcoxie'	Sarcoxie Euonymus		50cm	5 gal	1.3	1.3		132	
Sj	Spiraea japonica 'Goldflame'	Goldflame Spirea		40cm	3 gal	1.0	1.3		60	
Wf	Weigela florida 'Rumba'	Rumba Weigela		40cm	3 gal	1.0	1.3		72	
		•	•			•	•	TOTAL	264	
	PERENNIALS / GRASSES									
	PENEININIALS / GNASSES					1	1	1	1 1	

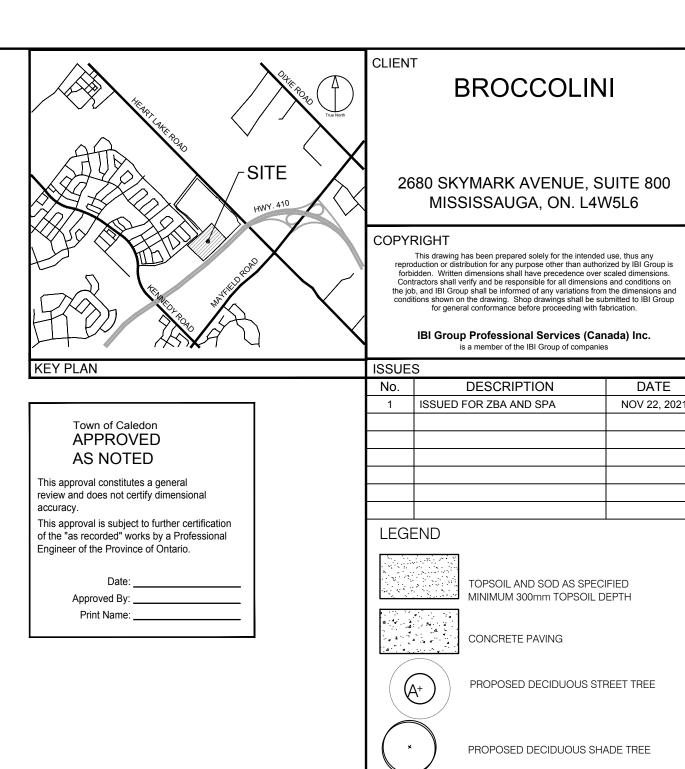

NOT FOR CONSTRUCTION

PROPOSED DECIDUOUS MULTISTEM TREE

PROPOSED DECIDUOUS SHRUBS

PROPOSED BROAD-LEAF EVERGREEN SHRUBS


PROPOSED CONIFEROUS TREE

PROPOSED ORNAMENTAL GRASSES

PROPOSED PERENNIALS

PROPOSED DECIDUOUS ORNAMENTAL TREE

SE

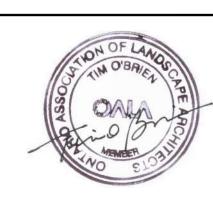

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Hamilton ON L8L 1H5 Canada
tel 905 546 1010 fax 905 546 1011
ibigroup.com

12304 HEART LAKE ROAD

CALEDON, ON. L7C 2J2

PROJECT NO: 135636	
DRAWN BY: LG	CHECKED BY: TO
PROJECT MGR: SA	APPROVED BY: TO


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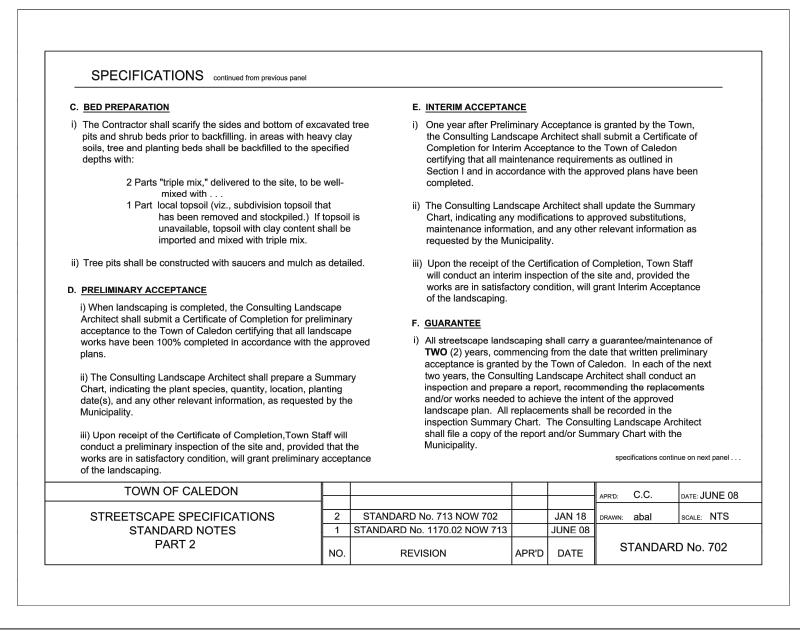
LANDSCAPE PLAN


SHEET NUMBER

L-4

PROJECT NO: 135636



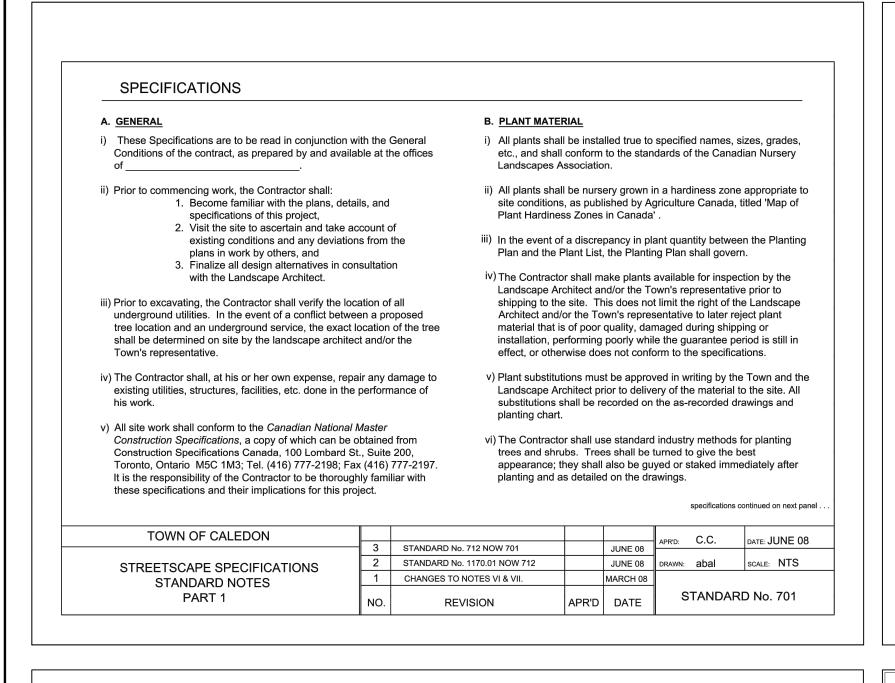

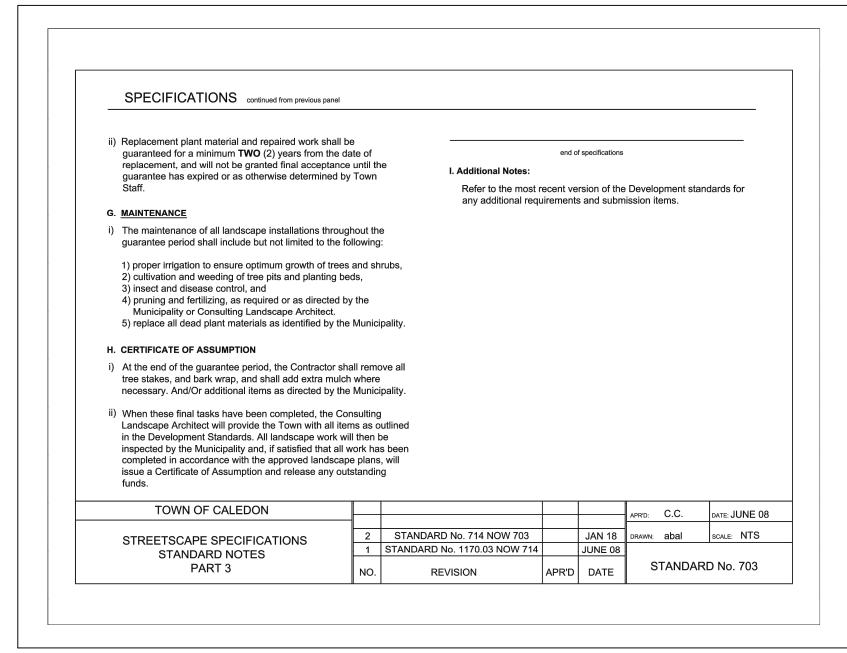



of the "as recorded" works by a Professional


Approved By: _____


Engineer of the Province of Ontario.


Print Name: ____


DATE NOV 22, 2021 LEGEND


NOT FOR CONSTRUCTION

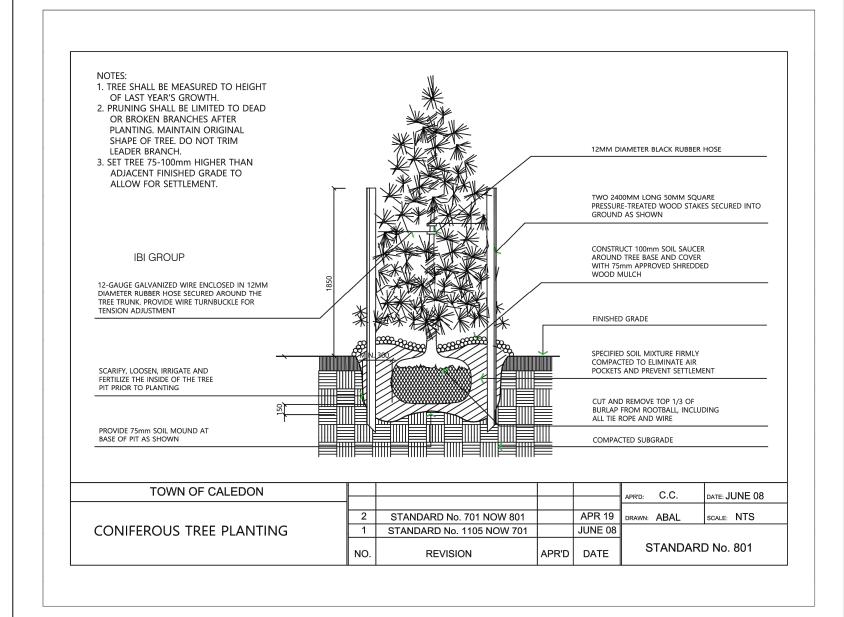


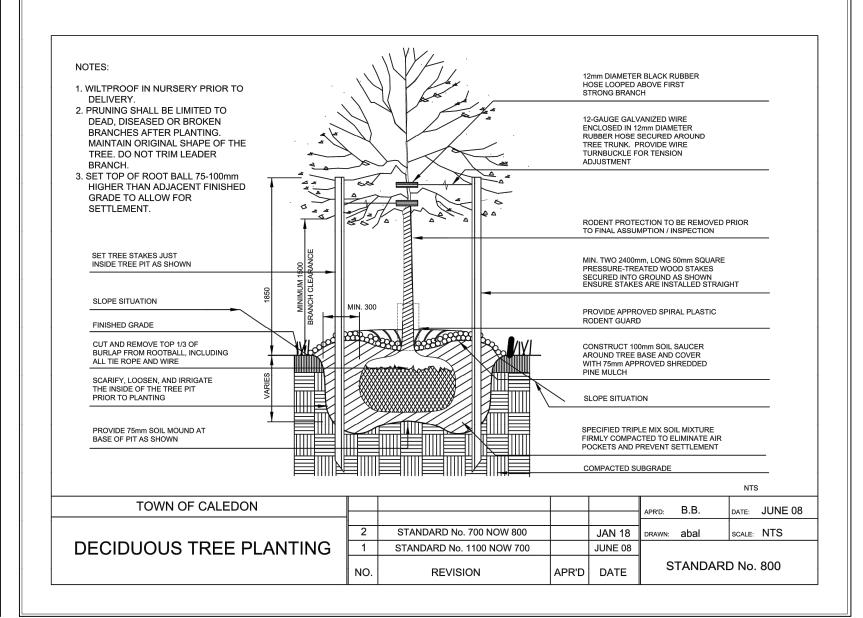


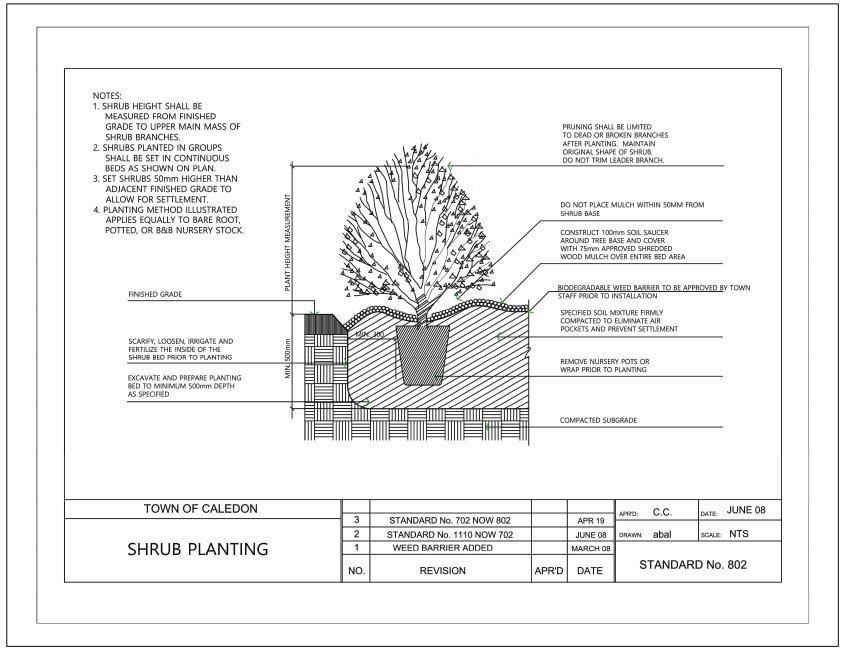

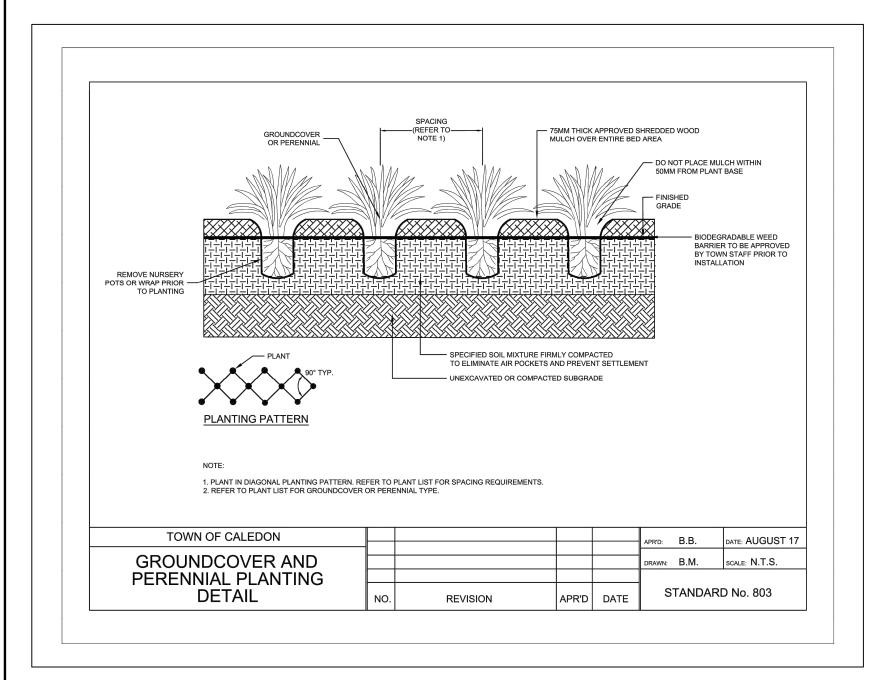

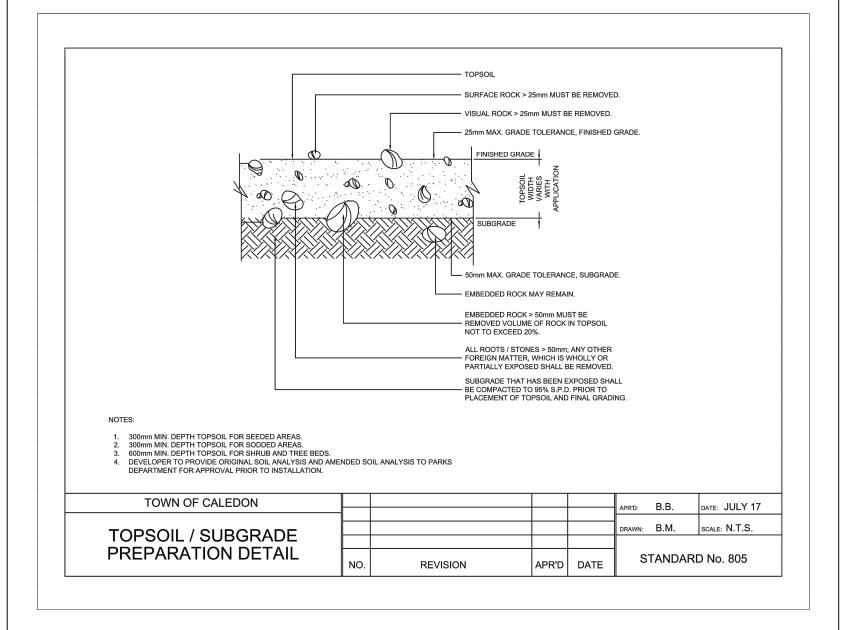

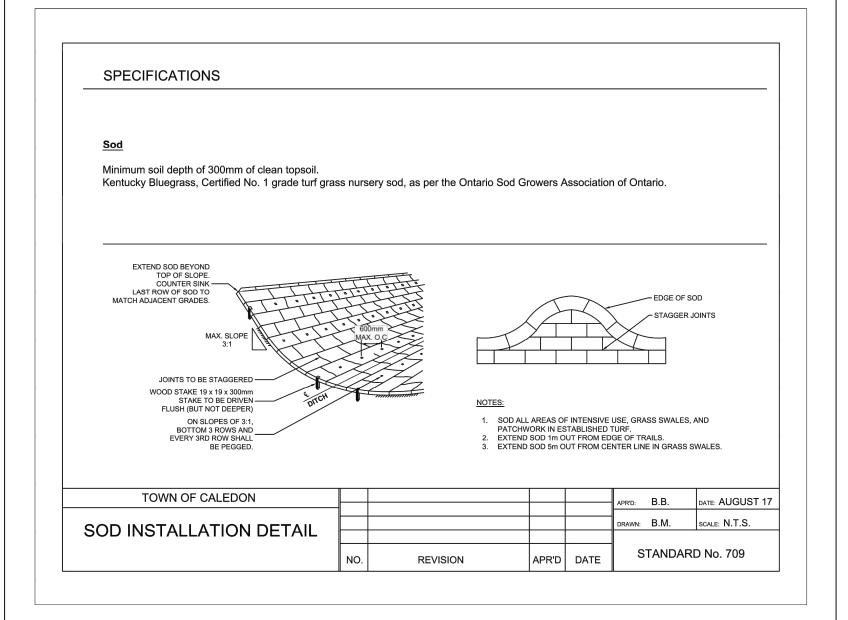

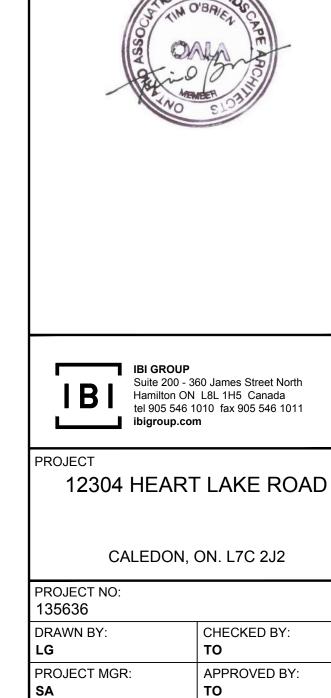

SHEET TITLE

SHEET NUMBER


LANDSCAPE DETAILS


ISSUE

SEAL



ATTACHMENT 4 - LANDSCAPE PLAN FOR PHASE 2

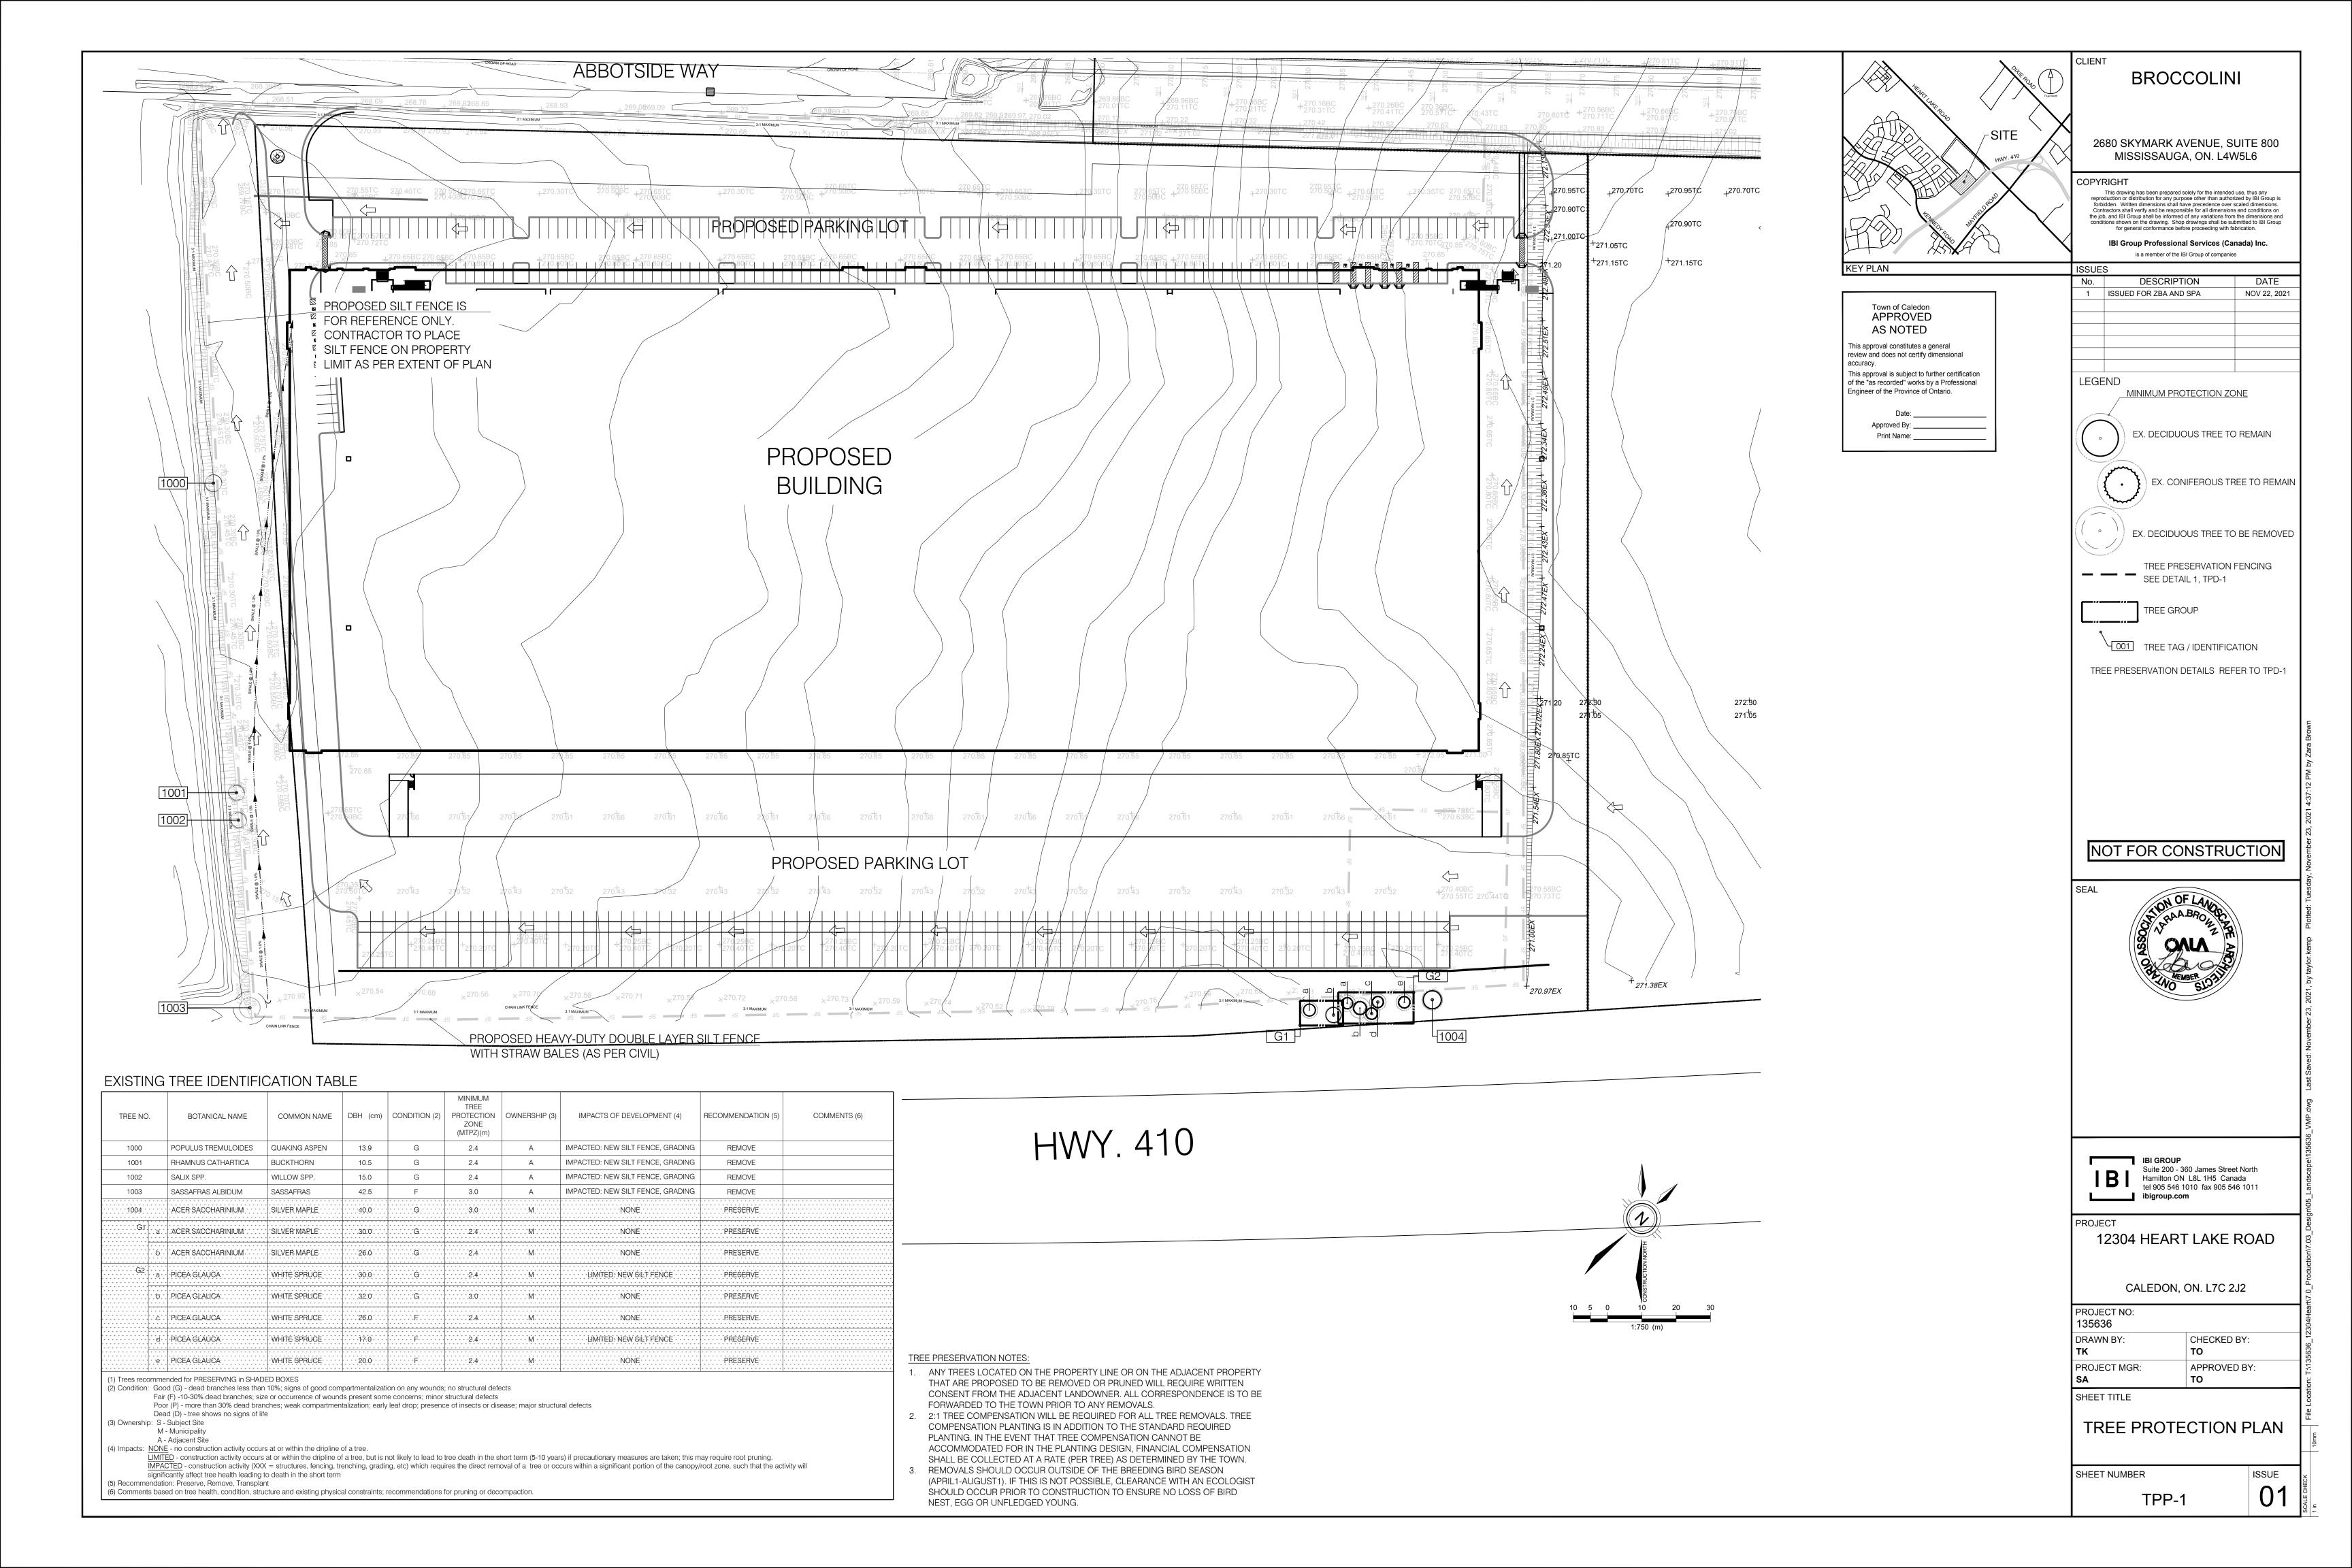

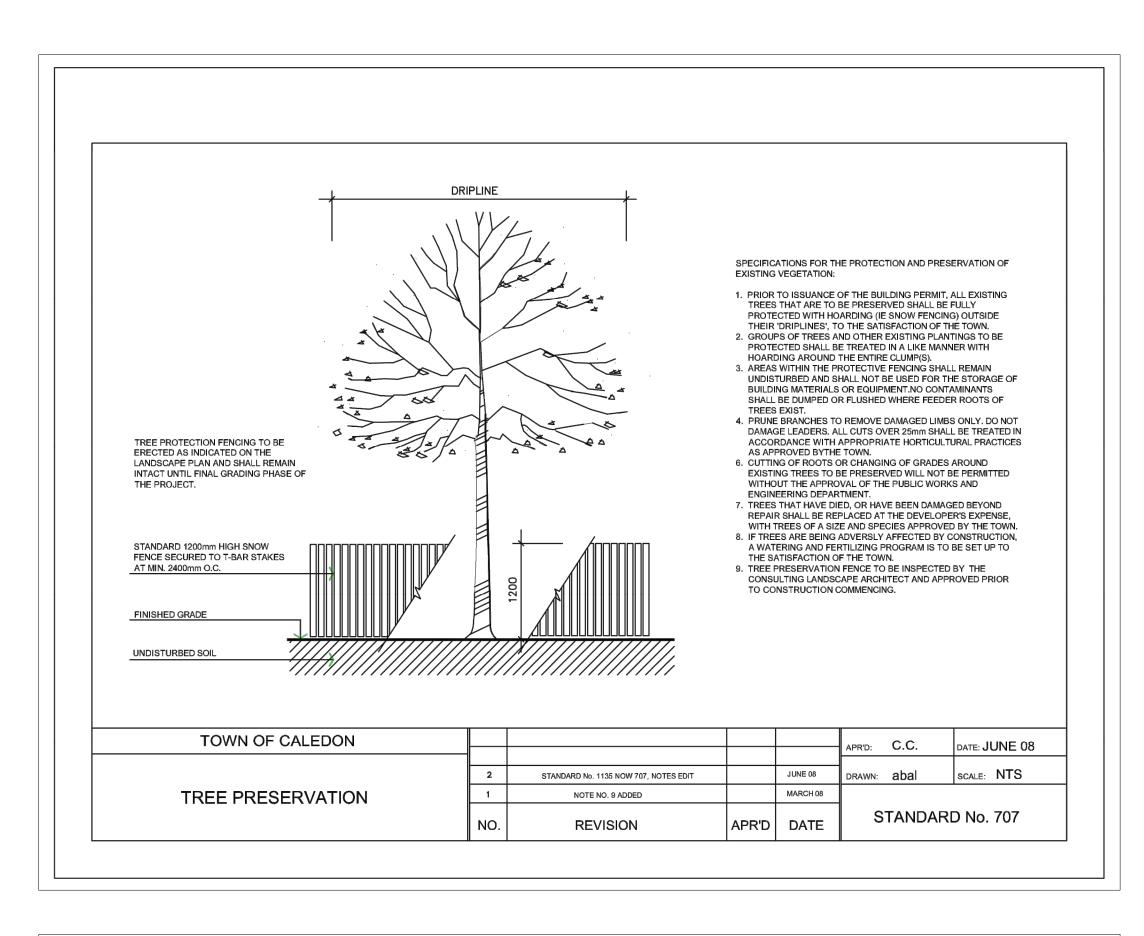

SPECIFICATIONS

A. Genera

The following Tree Preservation and Protection Measures will be undertaken to help eliminate and/or significantly reduce construction injury to all trees recommended for preservation. All temporary tree protection measures cited for retained trees must comply with the Town of Caledon Tree Protection Specifications and Details. Any variation from the standard tree protection measures must be approved in writing by the Town of Caledon.

B. <u>Pre-Construction Phase</u>

- Prior to construction, the trees to be preserved shall be protected with a Tree Protection Barrier. The barrier shall consist of 1.2m (4ft) high orange plastic snow fence wired to T-bars (see Town of Caledon Tree Preservation Fencing, STD 606).
- 2. If applicable, attach a filter cloth 600mm high to the construction side of the hoarding to act as sediment control. Sediment control fencing shall meet or exceed OPSD-219.110, and be installed to the satisfaction of the Town of Caledon.
- 3. All supports and bracing used to safely secure the barrier should be located outside the Tree Protection Zone (TPZ). All supports and
- bracing should minimize damage to roots.
 The TPZ fence is to be installed along the edge of the tree protection zones. This hoarding is to remain in place and remain in good condition throughout the entire duration of the project. Dismantling the tree protection barrier prior to approval by the Town of Caledon staff
- may constitute a contravention.
 The applicant shall notify the Town of Caledon and the consulting certified arborist or landscape architect to confirm that the tree protection barriers are in place.

- Where fill or excavated material must be temporarily located near a TPZ, a wooden barrier must be used to ensure no material enters the
- 7. Remove any garbage and foreign debris from the tree protection zones, daily.
- 8. For the trees that were recommended for removal and/or crown pruning that are within the TPZ limits, these activities are to be performed by a qualified ISA certified arborist prior to the installation of the Tree Protection Zone barriers and prior to the commencement of any construction activities. Install the Tree Protection Zone barrier as per Tree Preservation Fencing, STD 606 at the limits shown on the tree inventory and protection plan after the tree removal, whichever is greater, and crown pruning activities are completed.
- A Tree Protection Zone sign must be mounted on all sides of the tree protection barrier for the duration of site construction. The sign should be a minimum of 40cm x 60cm and made of white gator board or equivalent material.
- or equivalent material.

 10. The sign must be similar to the illustration shown below, or as directed by the Town of Caledon.

TREE PROTECTION ZONE

No work is permitted in the Tree Protection Zone

This includes construction works, grading, storage of trash or materials.

The tree protection barrier must not be removed without written

authorization of the Town of Caledon.

 All contractors and site visitors should be informed of the tree preservation and protection measures at a pre-construction meeting.

specifications continued on next panel...

TOWN OF CALEDON					APR'D:	B.B.	DATE: AUGUST
TREE PRESERVATION					DRAWN:	B.M.	SCALE: NTS
							•
STANDARD NOTES - PART 1	NO.	REVISION	APR'D	DATE	S	STANDAR	D No. 710

SPECIFICATIONS continued from previous panel

C. <u>During Construction Phase</u>

- All areas within the TPZ shall remain undisturbed for the duration of construction. There will be no grade changes, dumping, and storage of any materials, structures or equipment within these areas. The Tree Protection Barrier must not be removed without the written authorization of the Town of
- Minor grading works will be permitted at the edge of the preservation zone as required to correct localized depressions, and blend to existing grades. This work to be undertaken under the direct supervision of an ISA certified arborist.
 A certified ISA arborist will undertake proper root pruning in accordance with acceptable arboriculture practices when and if roots of retained trees are to be
- acceptable arboriculture practices when and if roots of retained trees are to be exposed, damaged, or severed by construction work. The exposed roots will be backfilled with appropriate material as soon as possible to prevent desiccation. Root pruning prior to excavation will help prevent necessary damage to tree roots. The use of low pressure hydrovac to expose roots is recommended, at no additional cost.
- 4. The Town of Caledon must be notified for all work that impacts the TPZ for temporary removal of a section of hoarding to gain access for fine grading or other works. All works are to be supervised by the Town of Caledon.
- other works. All works are to be supervised by the Town of Caledon.No cables, wire or ropes of any kind shall be wrapped around or installed in trees to be preserved.
- No contaminants will be dumped or flushed in the TPZ areas or where feeder roots of trees exist (generally beyond the TPZ areas).
- 7. Irrigate tree protection zones during drought conditions, June to September to reduce drought stress.
- Inspect the site daily to ensure hoarding is in place and in good condition.
 Inspect trees to monitor condition.


D. <u>Post Construction Phase</u>

- Following the completion of all site works including landscaping, and after review and approval by the Town of Caledon staff, the protective hoarding
- may be removed.

 After removal of the protective hoarding, the Tree Preservation Zones shall be inspected by the Town of Caledon staff. Any remaining dead, diseased, or hazardous limbs or trees are to be removed by an ISA certified arborist as directed by the consulting arborist or Town of Caledon staff.

end of specifications

TOWN OF CALEDON					APR'D:	B.B.	DATE: AUGUST 17
TREE PRESERVATION					DRAWN:	B.M.	scale: NTS
STANDARD NOTES - PART 2		REVISION	APR'D	DATE	S	TANDAR	D No. 711

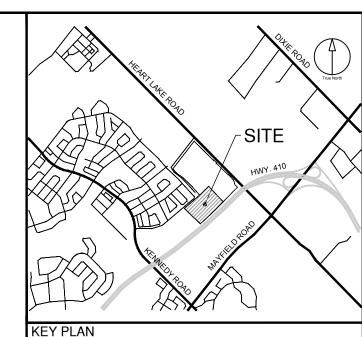

Print Name: _

BROCCOLINI

2680 SKYMARK AVENUE, SUITE 800 MISSISSAUGA, ON. L4W5L6


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Hamilton ON L8L 1H5 Canada
tel 905 546 1010 fax 905 546 1011
ibigroup.com

PROJECT

12304 HEART LAKE ROAD

CALEDON, ON. L7C 2J2

PROJECT NO:
135636

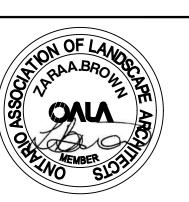DRAWN BY: CHECKED BY:
TK TO

PROJECT MGR: APPROVED BY:
SA TO


SHEET TITLE


TREE PROTECTION DETAILS


SHEET NUMBER

ISSUE 1

PD-1

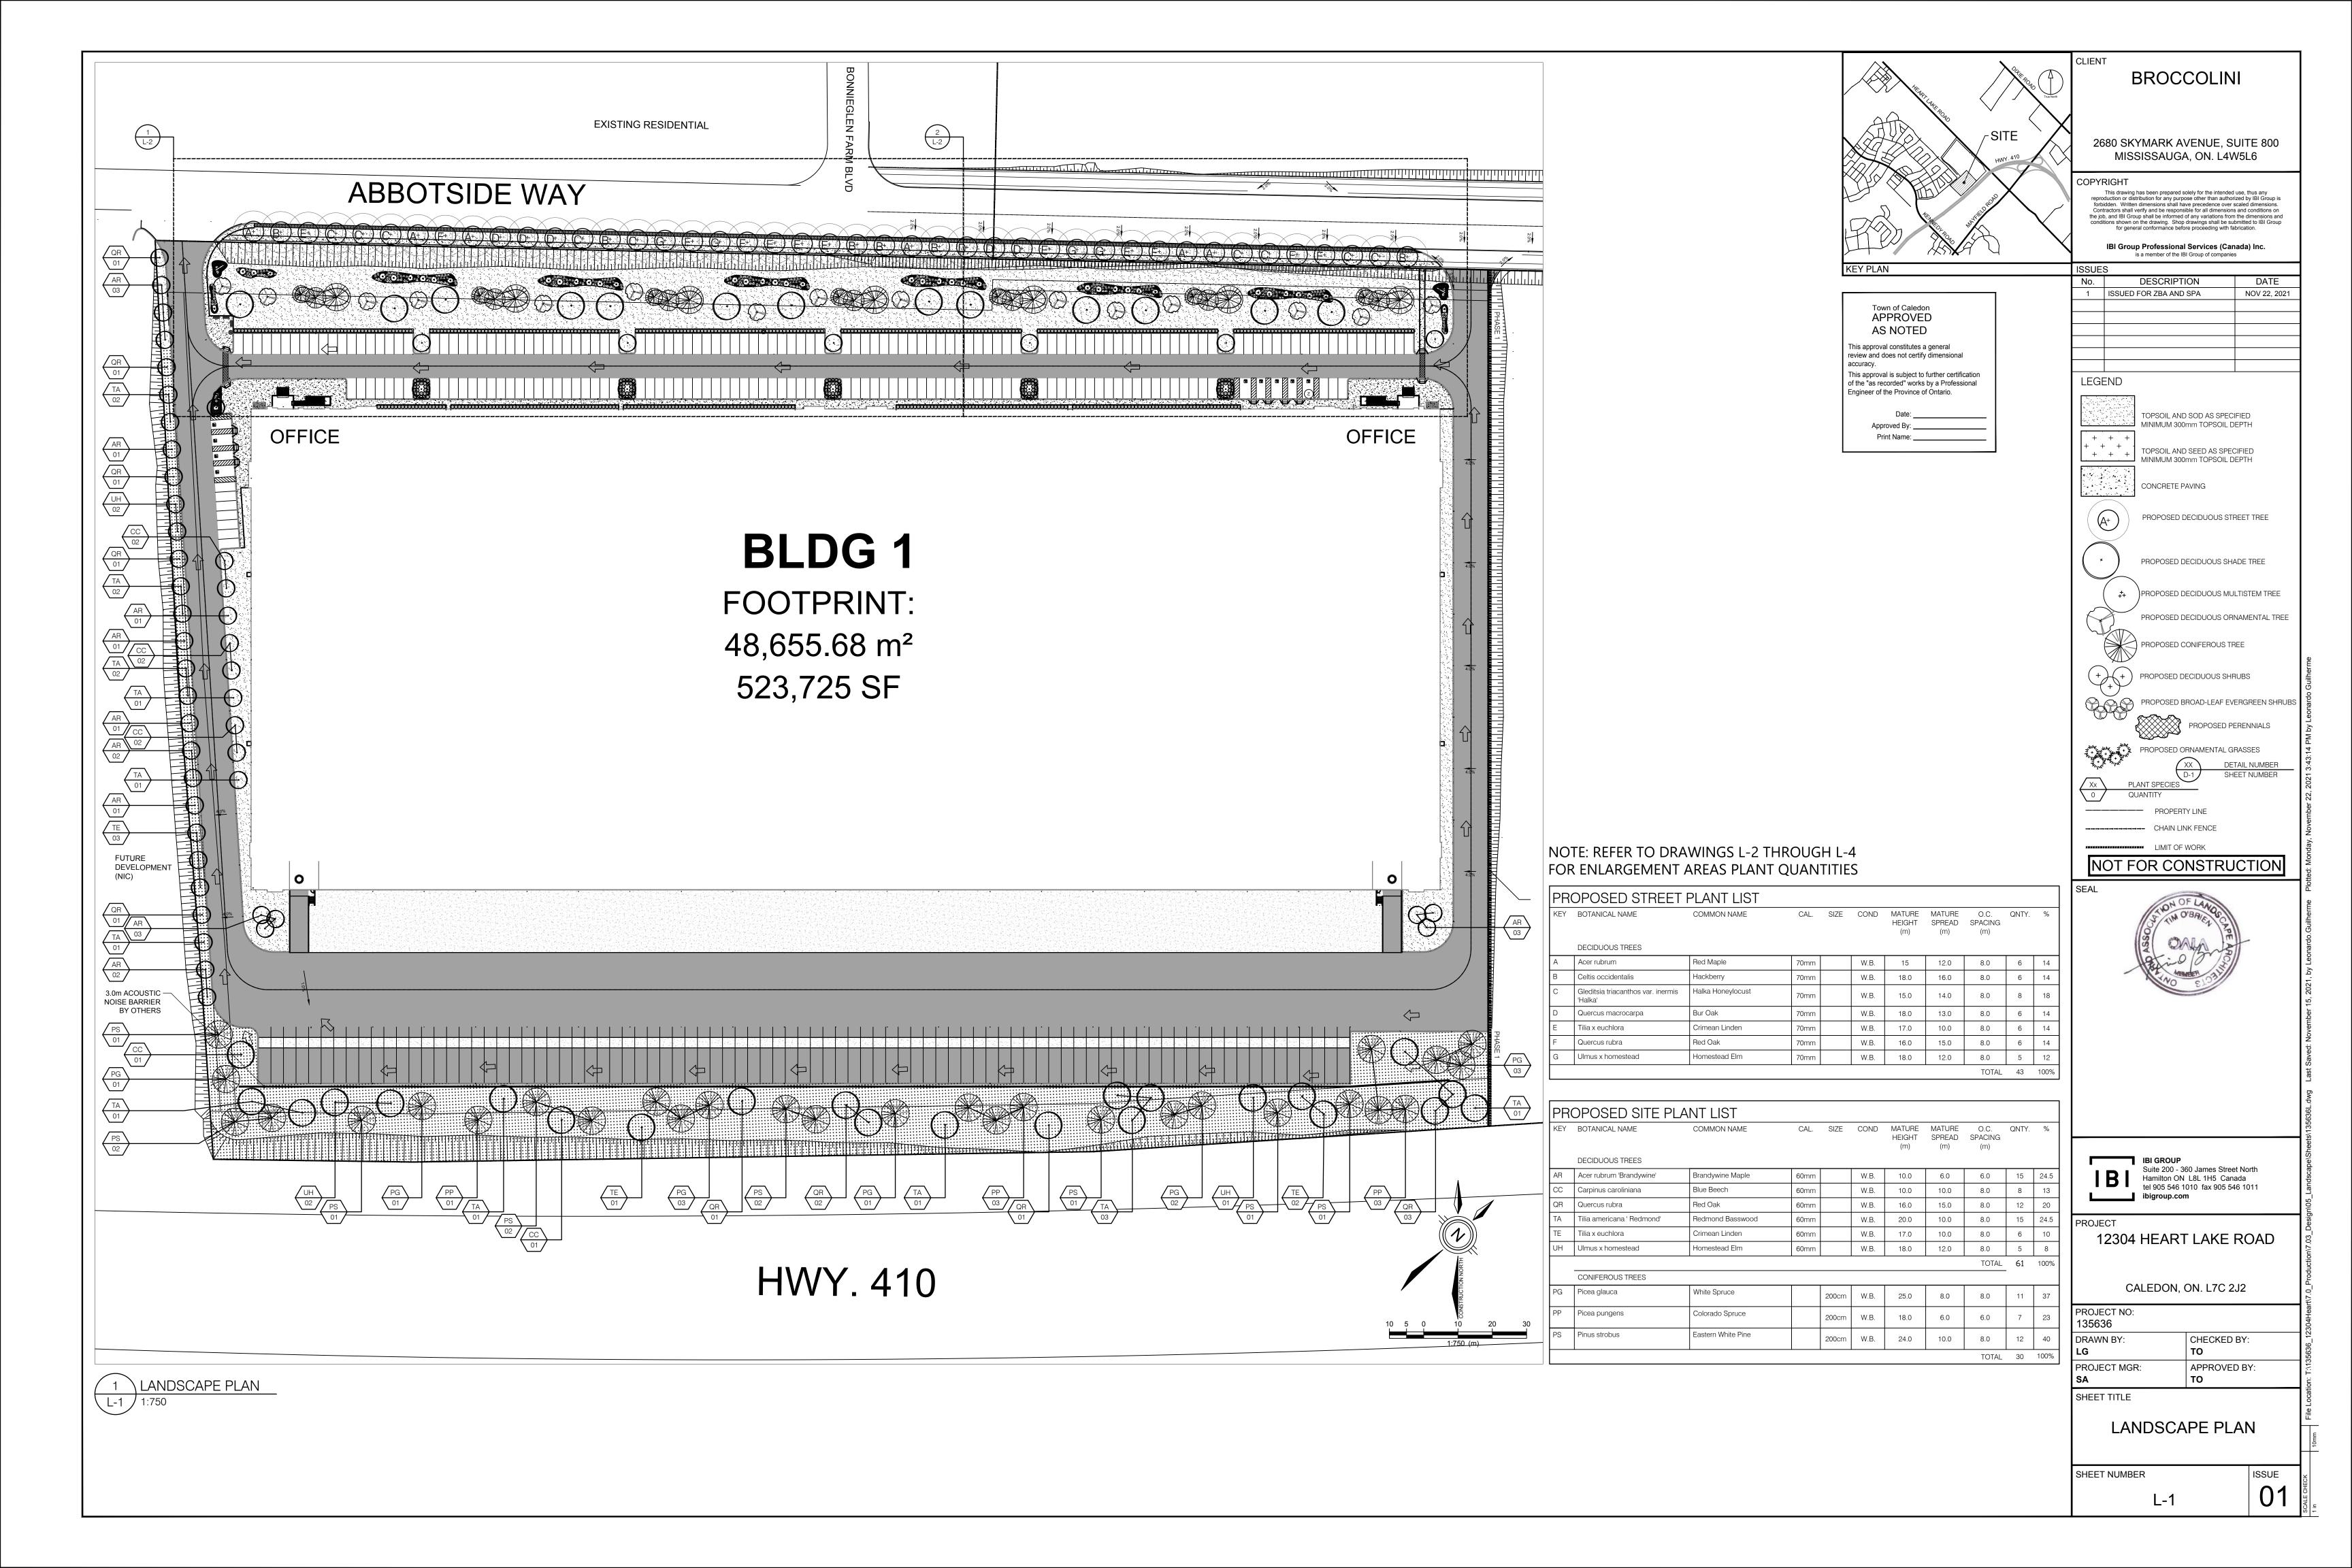


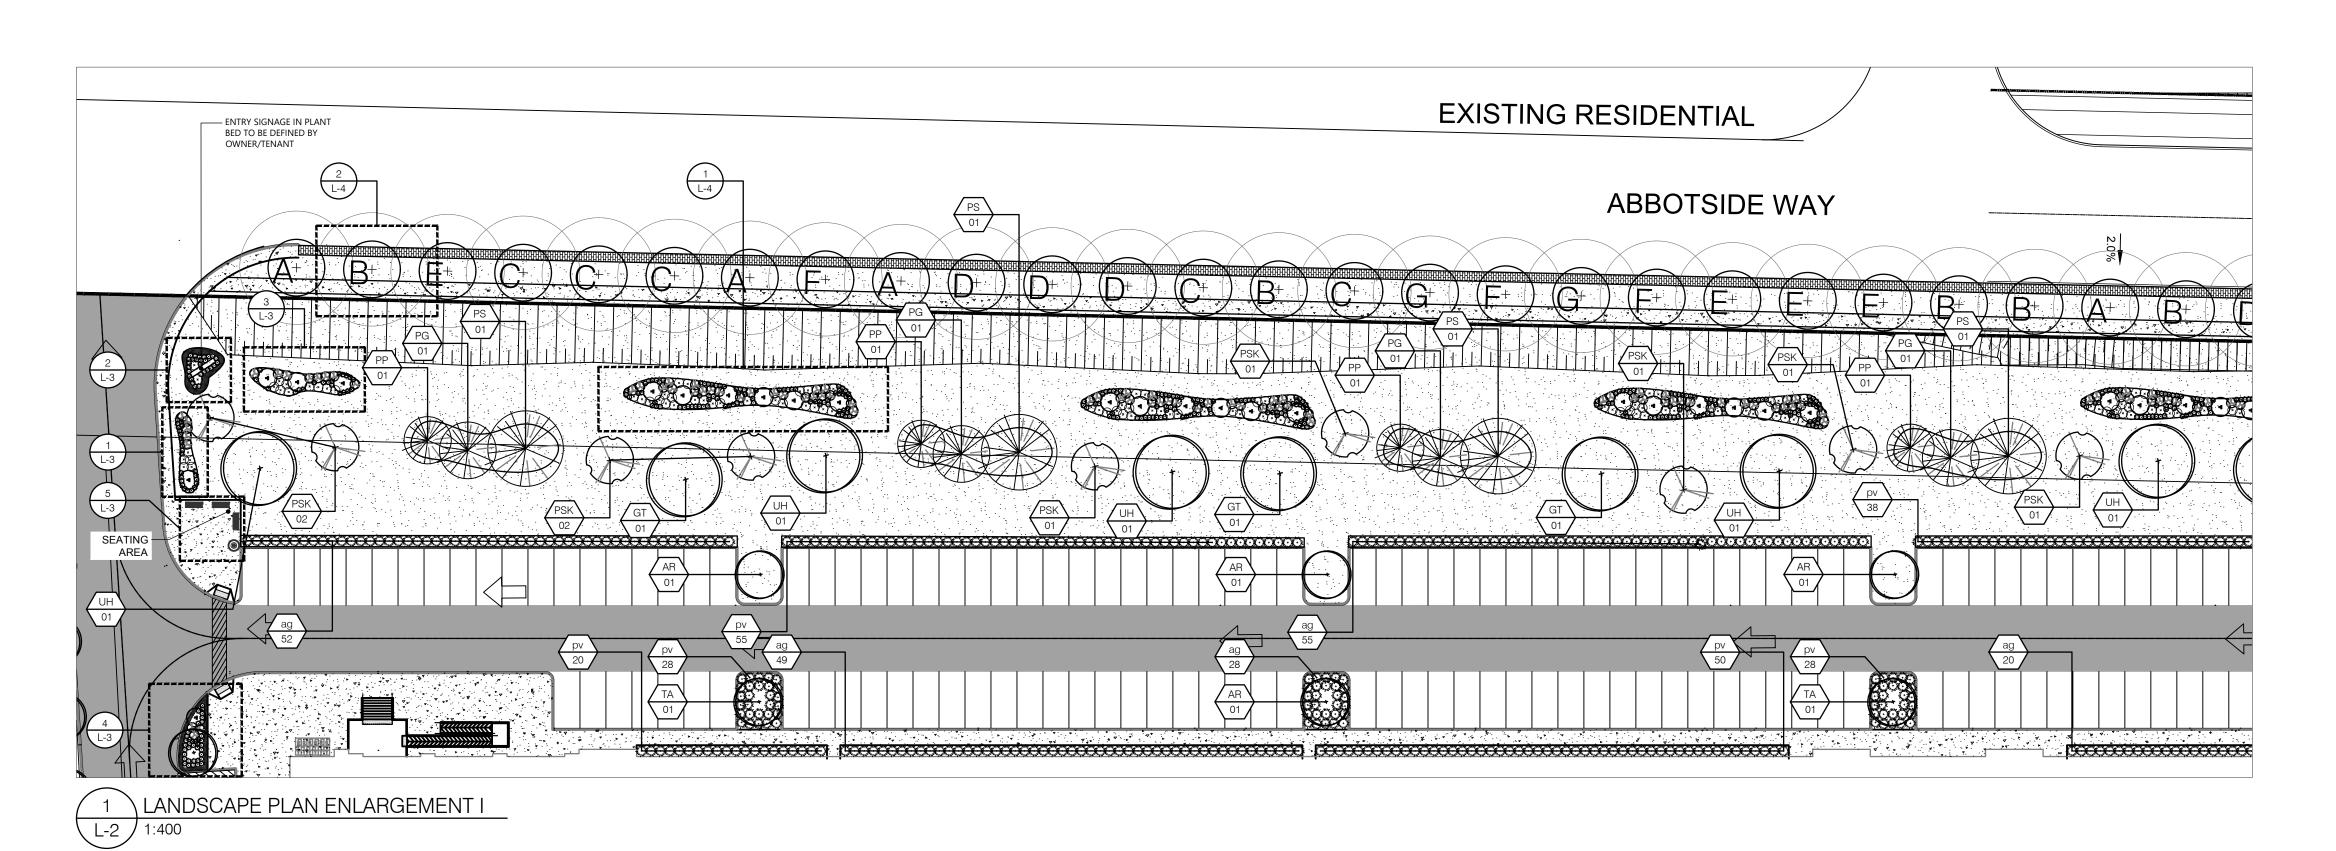

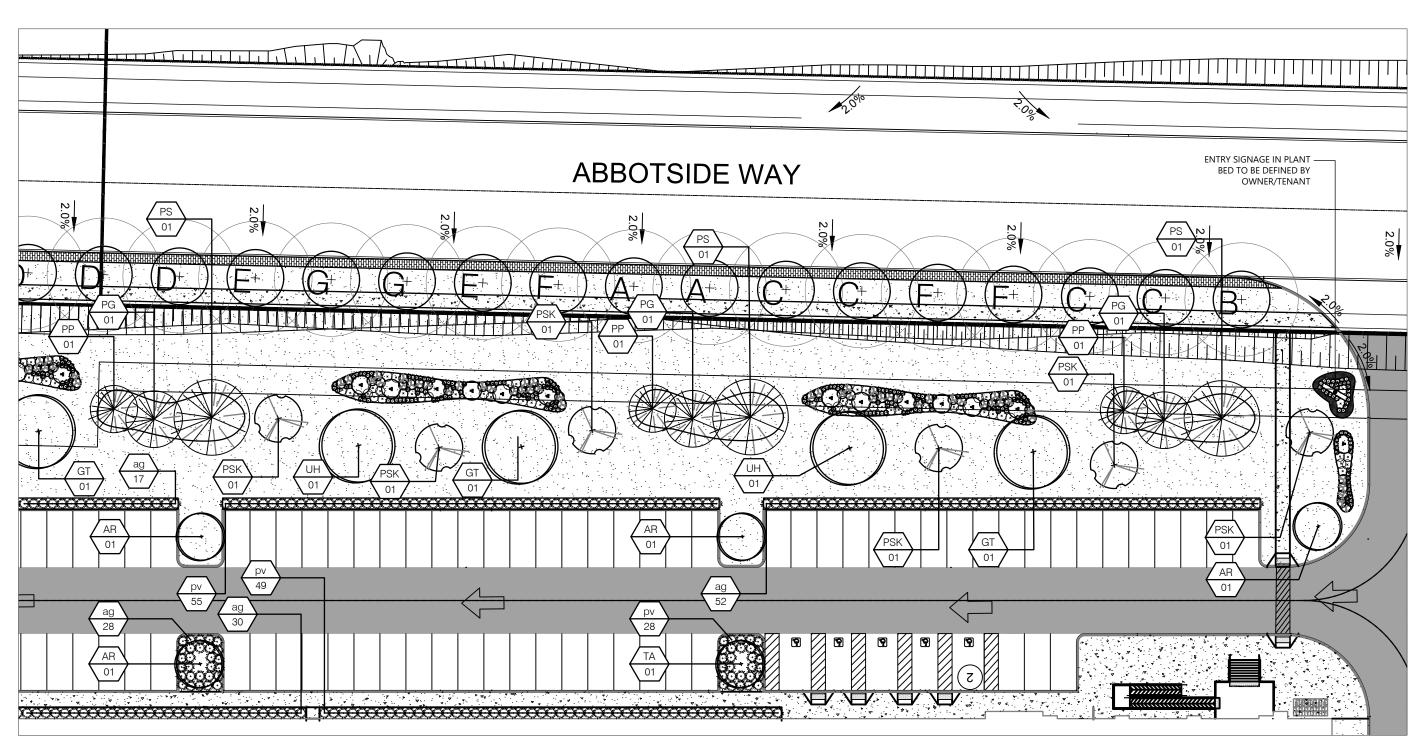

KEY	BOTANICAL NAME	COMMON NAME	CAL.	SIZE	COND	MATURE HEIGHT (m)	MATURE SPREAD (m)	O.C. SPACING (m)	QNTY.	%
	DECIDUOUS TREES									
AR	Acer rubrum 'Brandywine'	Brandywine Maple	60mm		W.B.	10.0	6.0	6.0	8	
GT	Gleditsia triacanthos var. inermis	Thornless Honeylocust	60mm		W.B.	18.0	13.0	6.0	6	
PSK	Prunus serrulata 'Kwanzan'	Kwanzan Flowering Cherry	60mm		W.B.	10.0	6.0	6.0	15	
TA	Tilia americana ' Redmond'	Redmond Basswood	60mm		W.B.	20.0	10.0	8.0	3	
UH	Ulmus x homestead	Homestead Elm	60mm		W.B.	18.0	12.0	8.0	7	
								TOTAL	39	
	CONIFEROUS TREES									
PG	Picea glauca	White Spruce		200cm	W.B.	25.0	8.0		7	
1 4	9									
PS	Pinus strobus	Eastern White Pine		200cm	W.B.	24.0	10.0		7	
PS		Eastern White Pine Colorado Spruce		200cm 200cm	W.B.	24.0 18.0	10.0 6.0		7	
	Pinus strobus							TOTAL	'	
PS	Pinus strobus							TOTAL	7	
PS	Pinus strobus Picea pungens							TOTAL	7	

\ LANDSCAPE PLAN ENLARGEMENT II L-2 / 1:400

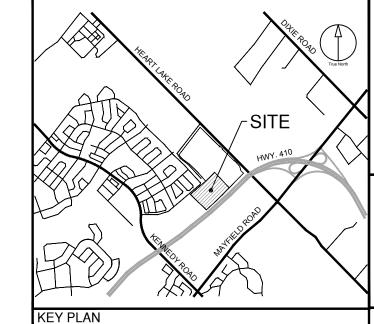

BROCCOLINI

2680 SKYMARK AVENUE, SUITE 800 MISSISSAUGA, ON. L4W5L6

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IBI Group Professional Services (Canada) Inc. is a member of the IBI Group of companies

Town of Caledon APPROVED AS NOTED This approval constitutes a general review and does not certify dimensional This approval is subject to further certification of the "as recorded" works by a Professional Engineer of the Province of Ontario. Approved By: _____ Print Name: _____

ISSUE	S	
No.	DESCRIPTION	DATE
1	ISSUED FOR ZBA AND SPA	NOV 22, 2021
LEGI	END	
39, 39,	H. 201 101 1	

TOPSOIL AND SOD AS SPECIFIED MINIMUM 300mm TOPSOIL DEPTH

CONCRETE PAVING

PROPOSED DECIDUOUS STREET TREE

+ PROPOSED DECIDUOUS MULTISTEM TREE PROPOSED DECIDUOUS ORNAMENTAL TREE PROPOSED CONIFEROUS TREE

PROPOSED DECIDUOUS SHRUBS

PROPOSED DECIDUOUS SHADE TREE

PROPOSED BROAD-LEAF EVERGREEN SHRUBS

PROPOSED PERENNIALS PROPOSED ORNAMENTAL GRASSES

QUANTITY

NOT FOR CONSTRUCTION



IBI GROUP Suite 200 - 360 James Street North Hamilton ON L8L 1H5 Canada tel 905 546 1010 fax 905 546 1011 ibigroup.com

12304 HEART LAKE ROAD


CALEDON, ON. L7C 2J2

- 1	PROJECT NO: 135636	
	DRAWN BY: LG	CHECKED BY: TO
- 1	PROJECT MGR: SA	APPROVED BY:


SHEET TITLE

LANDSCAPE PLAN


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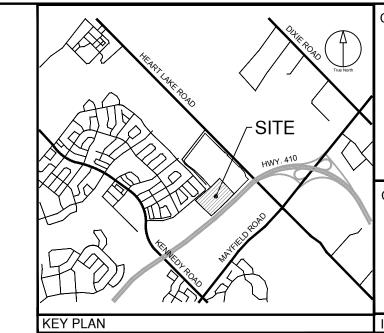


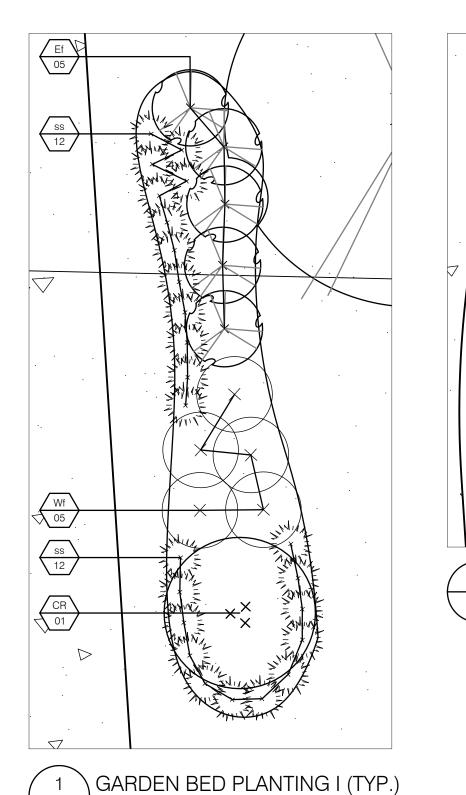L-3 1:50

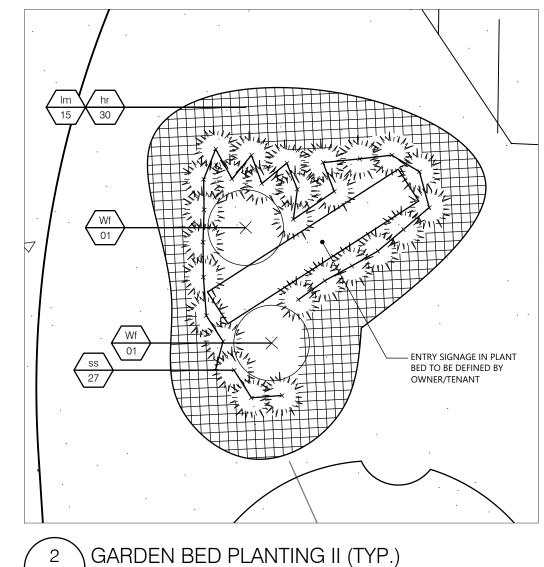

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Print Name: ____

200 SERIES

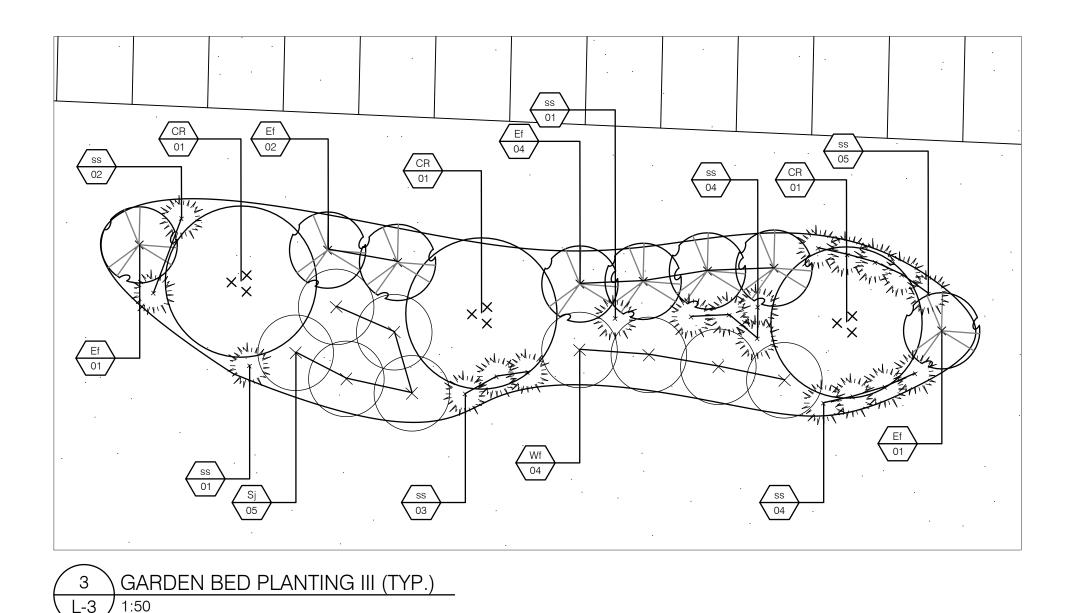WEIGHT: 194.5lbs (88.2kg)

T 800 716 5506 F 877 260 9393 www.maglin.com sales@maglin.com

BROCCOLINI

2680 SKYMARK AVENUE, SUITE 800 MISSISSAUGA, ON. L4W5L6

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DATE

NOV 22, 2021

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ISSUES Town of Caledon APPROVED AS NOTED This approval constitutes a general review and does not certify dimensional This approval is subject to further certification LEGEND of the "as recorded" works by a Professional Engineer of the Province of Ontario.

DESCRIPTION ISSUED FOR ZBA AND SPA TOPSOIL AND SOD AS SPECIFIED

MINIMUM 300mm TOPSOIL DEPTH CONCRETE PAVING

PROPOSED DECIDUOUS SHADE TREE → PROPOSED DECIDUOUS MULTISTEM TREE

→ PROPOSED DECIDUOUS MULTISTEM TREE

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→ PROPOSED MULTISTEM TREE

→

PROPOSED DECIDUOUS SHRUBS

PROPOSED DECIDUOUS ORNAMENTAL TREE

PROPOSED BROAD-LEAF EVERGREEN SHRUBS

PROPOSED PERENNIALS

PROPOSED ORNAMENTAL GRASSES

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SEAL



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PROJECT 12304 HEART LAKE ROAD

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CALEDON, ON. L7C 2J2

PROJECT NO: 135636 DRAWN BY: CHECKED BY:

PROJECT MGR:

SHEET TITLE


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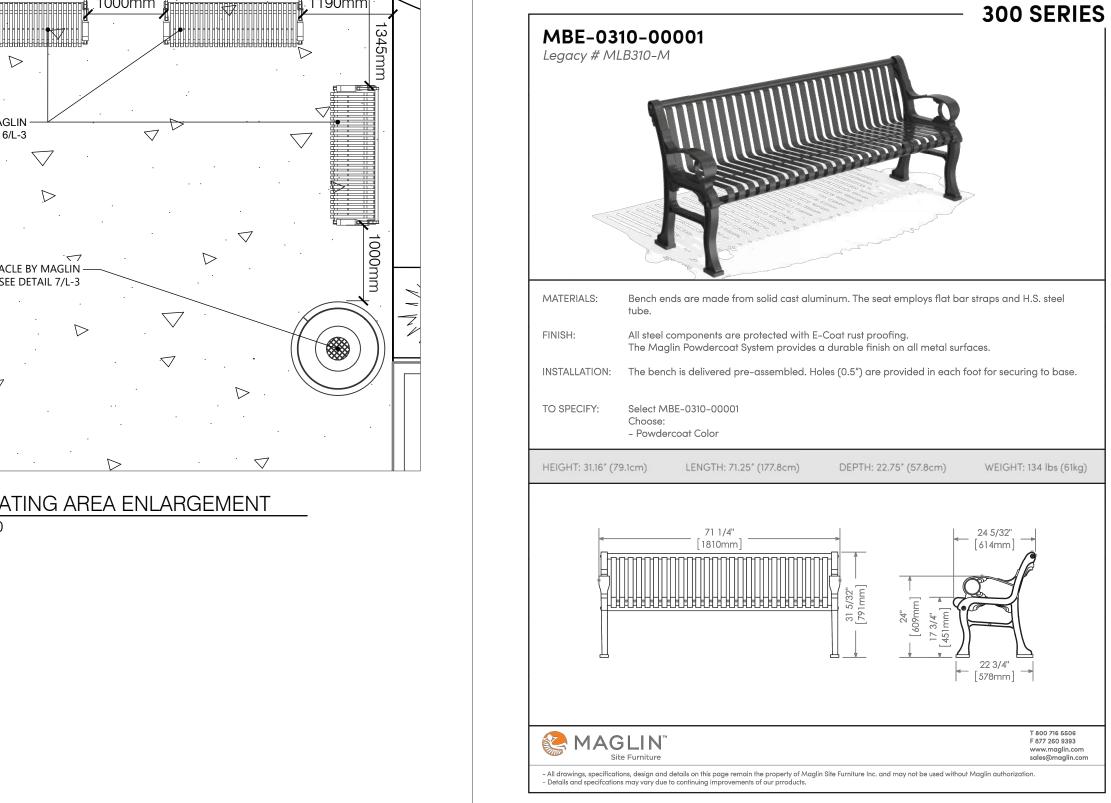
TO

APPROVED BY:

SHEET NUMBER

1190mm BENCH BY MAGLIN -SEE DETAIL 6/L-3 abla . ablaTRASH RECEPTACLE BY MAGLIN — SEE DETAIL 7/L-3



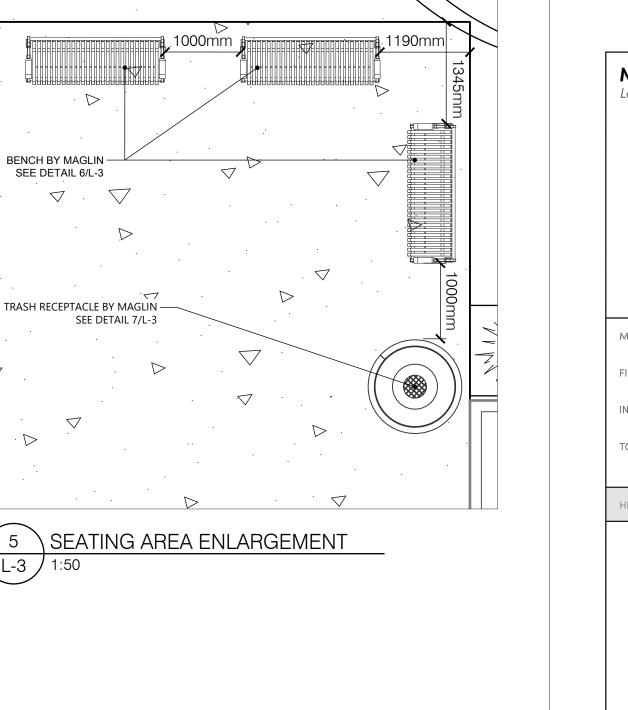



KEY	BOTANICAL NAME	COMMON NAME	CAL.	SIZE	COND	MATURE HEIGHT (m)	MATURE SPREAD (m)	O.C. SPACING (m)	QNTY.	%
	DECIDUOUS TREES									
AR	Acer rubrum 'Brandywine'	Brandywine Maple	60mm		W.B.	10.0	6.0	6.0	1	
CR	Cornus racemosa	Gray Dogwood	Clump	200cm	W.B.	10.0	10.0	10.0	9	
		,	,					TOTAL	10	
	SHRUBS									
Ef	Euonymus fortunei 'Sarcoxie'	Sarcoxie Euonymus		50cm	5 gal	1.3	1.3	1.0	29	
Sj	Spiraea japonica 'Goldflame'	Goldflame Spirea		40cm	3 gal	1.0	1.3	1.0	10	
Wf	Weigela florida 'Rumba'	Rumba Weigela		40cm	3 gal	1.0	1.3	1.0	22	
			•				•	TOTAL	61	
	PERENNIALS / GRASSES									
hr	Hemerocallis 'Rocket City'	Rocket City Daylily			1 gal	0.9	0.6		90	
lm	Liriope muscari 'Big Blue'	Giant Lily Turf			1 gal	0.5	0.4		30	
SS	Schizachyrium scoparium	Little Bluestem			1 gal	1.3	0.7		179	
	1		<u> </u>					TOTAL	179	

GARDEN BED PLANTING IV



1 x 32 Gallon Polyethylene Liner

securing to base.

Select MTR-0250-00001

- Powdercoat Color

TO SPECIFY:

HEIGHT: 35 1/2" (90cm)

DESCRIPTION: 200 Series - 250 Trash Receptacle: Heavy Duty Steel Flat Bar and H.S. Steel Frame, Bottles/Cans Lid,


All steel components are protected with E-Coat rust proofing. The Maglin Powdercoat System provides a durable finish on all metal surfaces.


INSTALLATION: The trash container is delivered pre-assembled. Holes (0.5") are provided in each mounting foot for

DIAMETER: 24 5/8" (62.5cm)

MTR-0250-00001


Legacy # MLWR250-32-BC

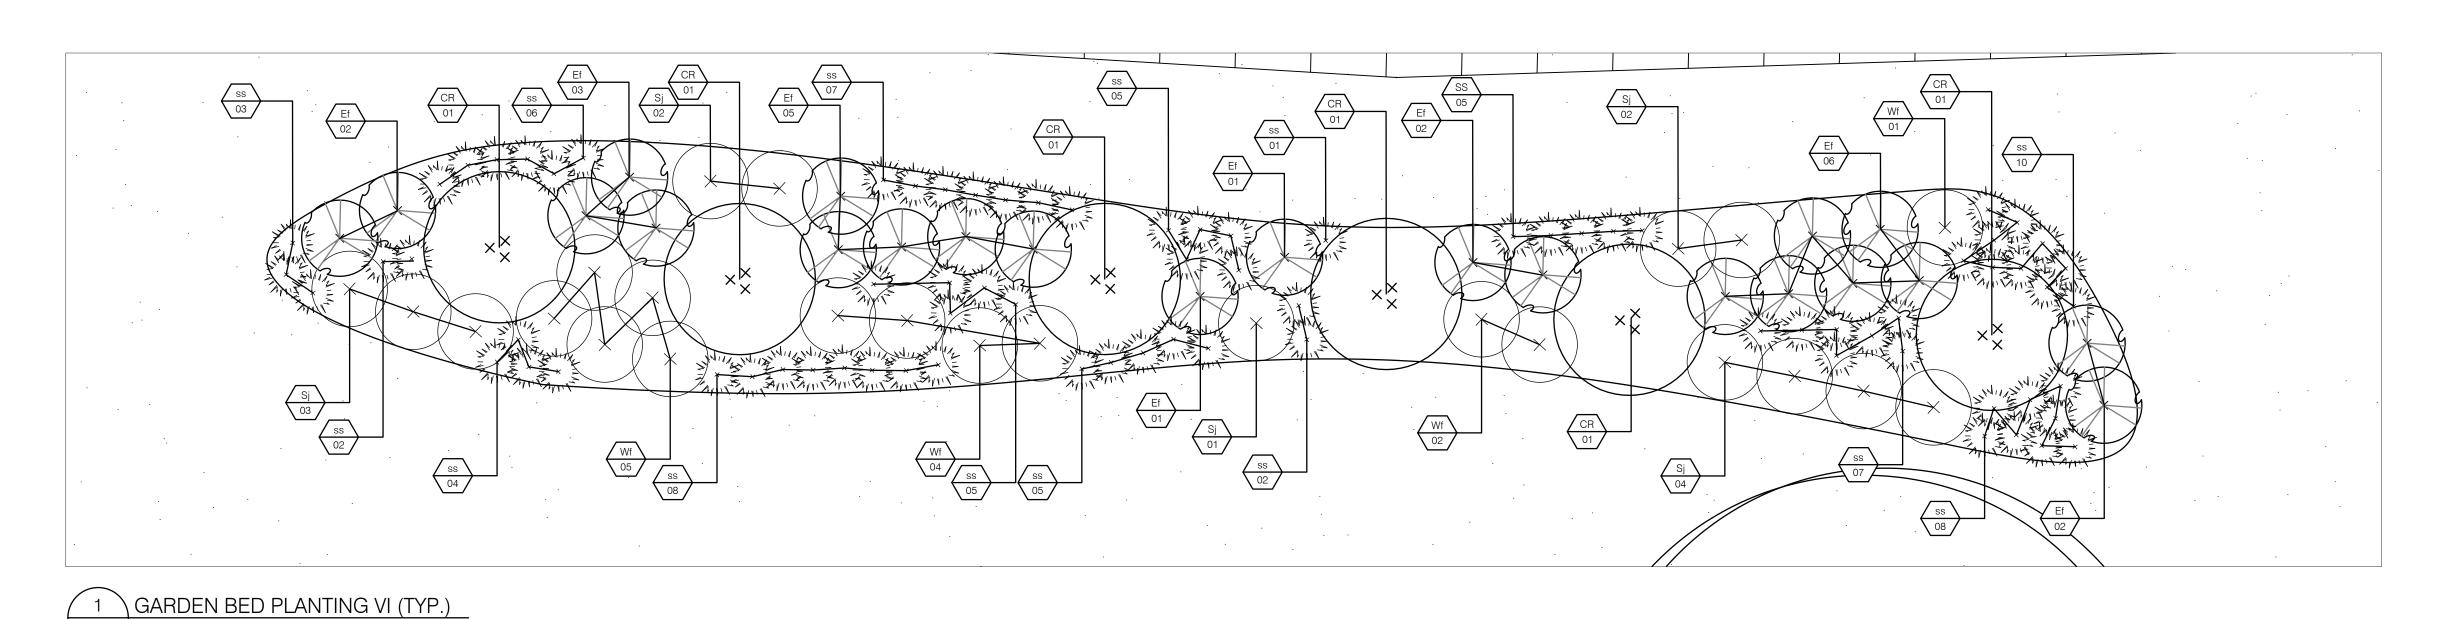

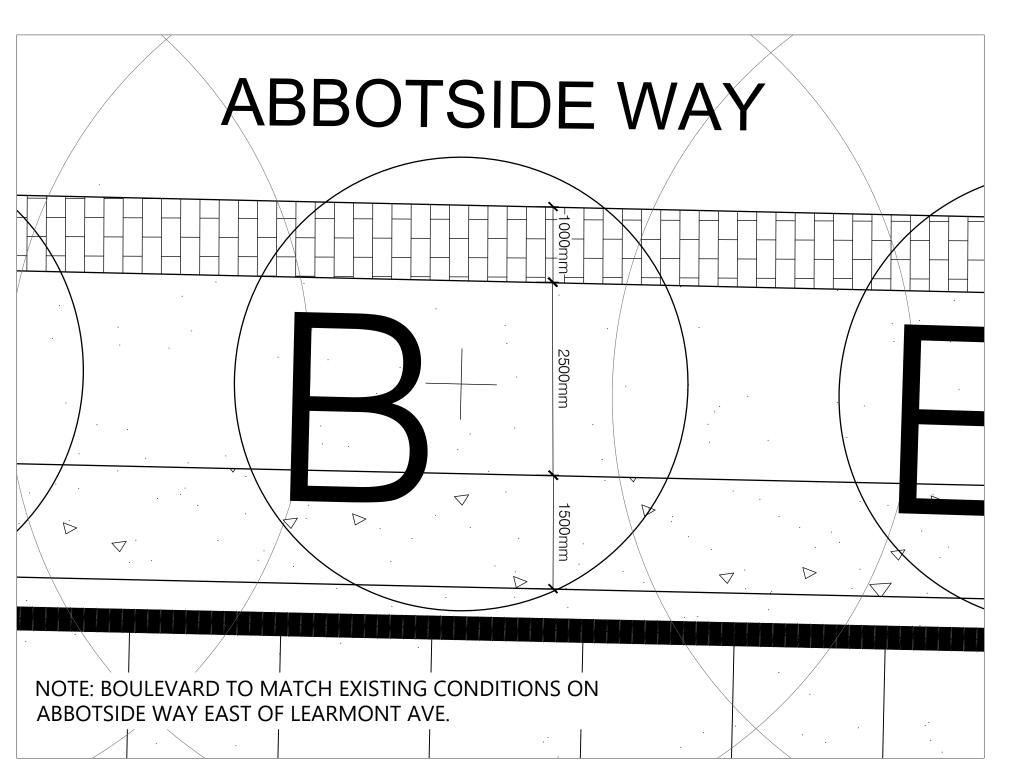

2 BOULEVARD DETAIL

KEY	BOTANICAL NAME	COMMON NAME	CAL.	SIZE	COND	MATURE HEIGHT (m)	MATURE SPREAD (m)	O.C. SPACING (m)	QNTY.	%
	DECIDUOUS TREES									
CR	Cornus racemosa	Gray Dogwood	Clump	200cm	W.B.	10.0	10.0	10.0	36	
			<u>'</u>			•	•	TOTAL	36	
	SHRUBS									
Ef	Euonymus fortunei 'Sarcoxie'	Sarcoxie Euonymus		50cm	5 gal	1.3	1.3		132	
Sj	Spiraea japonica 'Goldflame'	Goldflame Spirea		40cm	3 gal	1.0	1.3		60	
Wf	Weigela florida 'Rumba'	Rumba Weigela		40cm	3 gal	1.0	1.3		72	
		•	•			•	•	TOTAL	264	
	PERENNIALS / GRASSES									
	PENEININIALS / GNASSES					1	1	1	1 1	

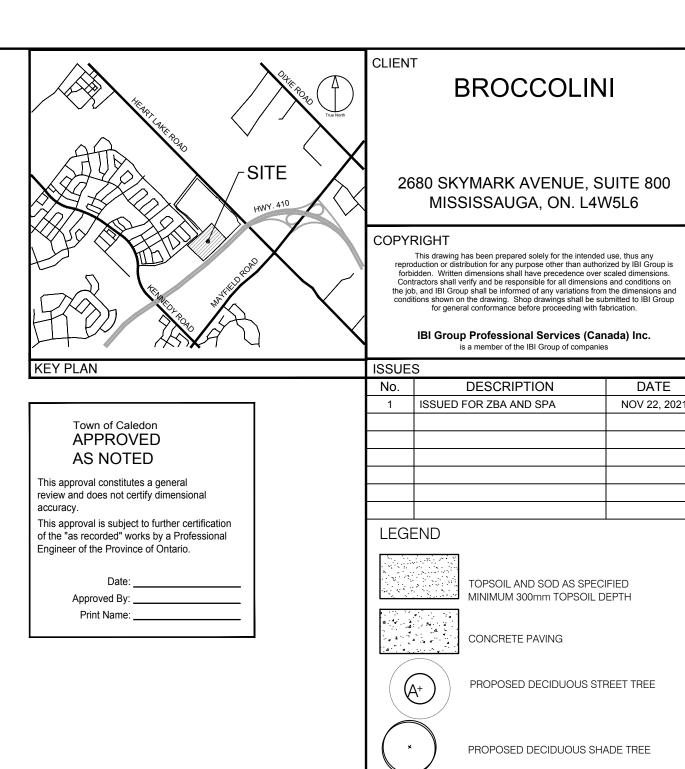

NOT FOR CONSTRUCTION

PROPOSED DECIDUOUS MULTISTEM TREE

PROPOSED DECIDUOUS SHRUBS

PROPOSED BROAD-LEAF EVERGREEN SHRUBS


PROPOSED CONIFEROUS TREE

PROPOSED ORNAMENTAL GRASSES

PROPOSED PERENNIALS

PROPOSED DECIDUOUS ORNAMENTAL TREE

SE

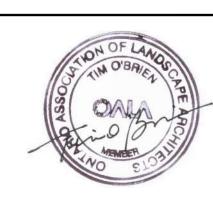

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12304 HEART LAKE ROAD

CALEDON, ON. L7C 2J2

PROJECT NO: 135636	
DRAWN BY: LG	CHECKED BY: TO
PROJECT MGR: SA	APPROVED BY: TO


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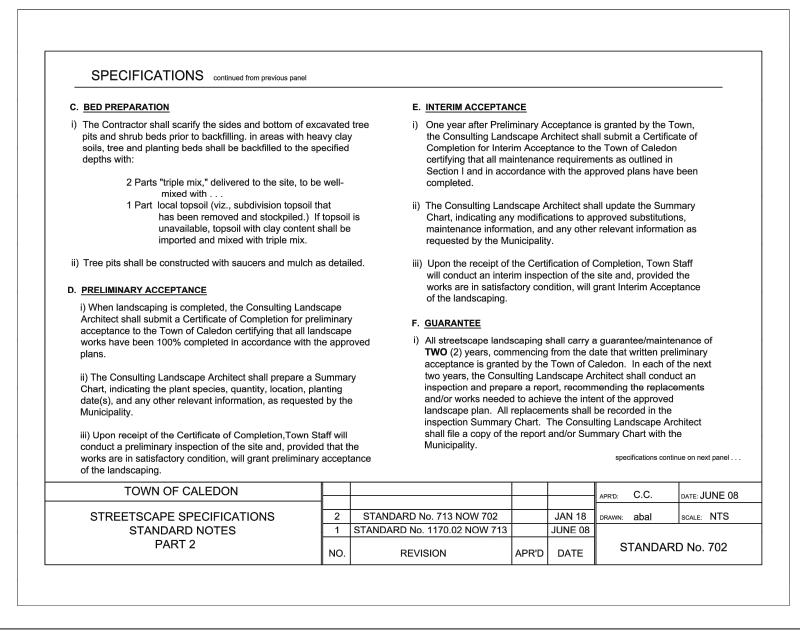
LANDSCAPE PLAN


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L-4

PROJECT NO: 135636





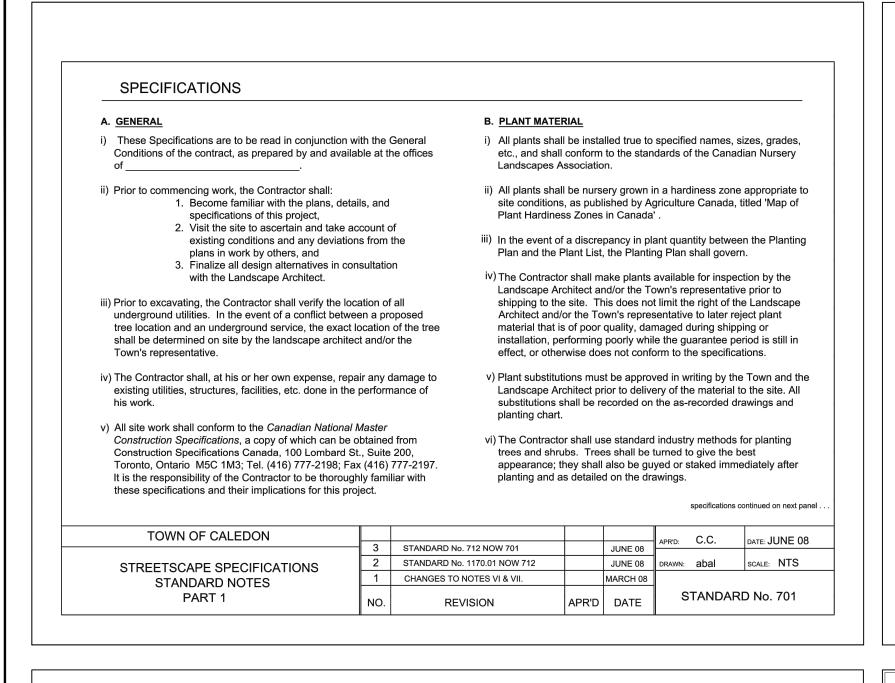

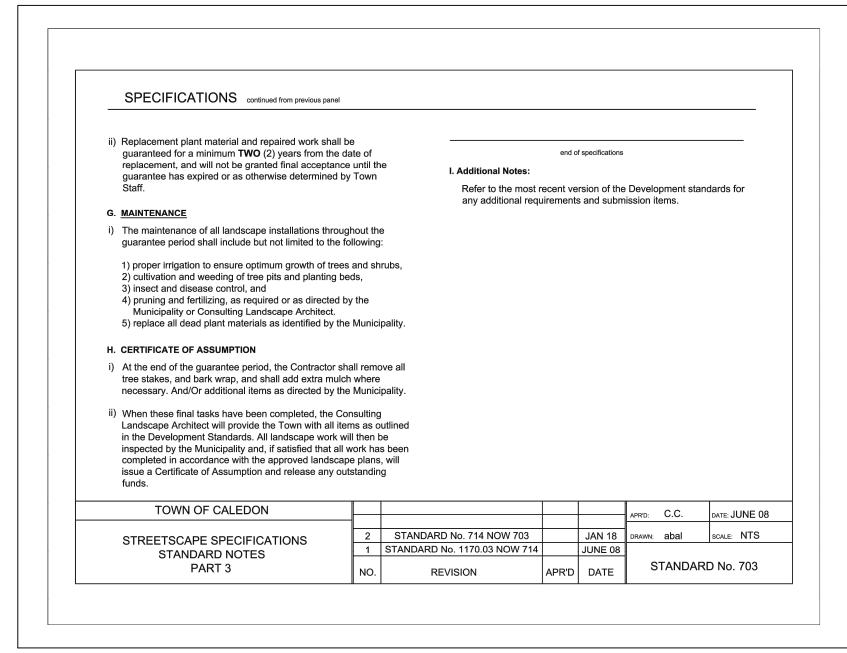

of the "as recorded" works by a Professional


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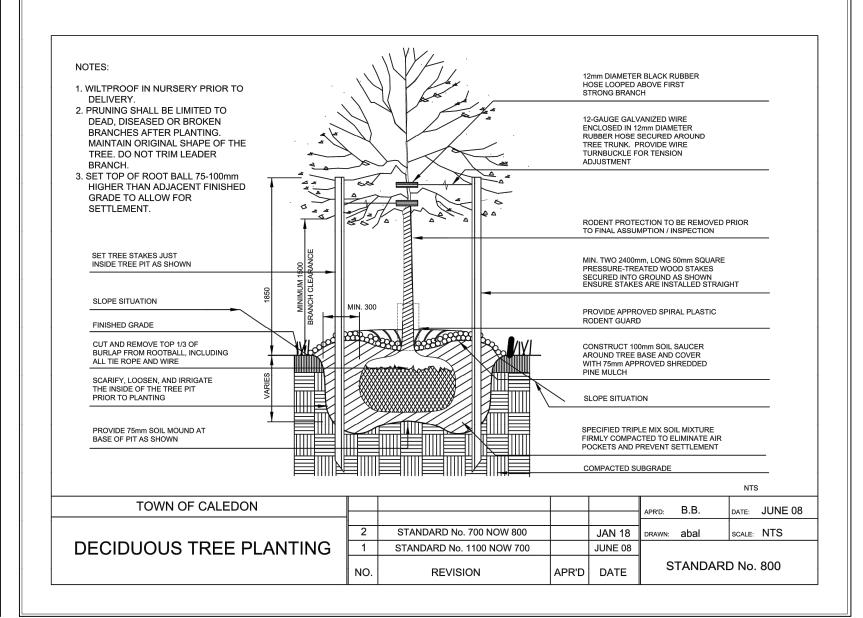
Engineer of the Province of Ontario.


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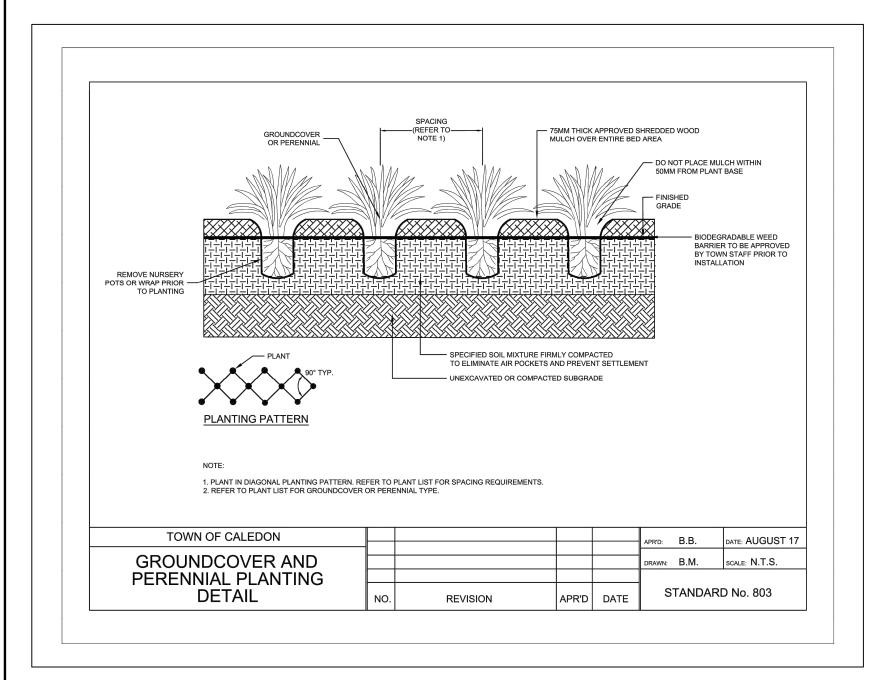
DATE NOV 22, 2021 LEGEND


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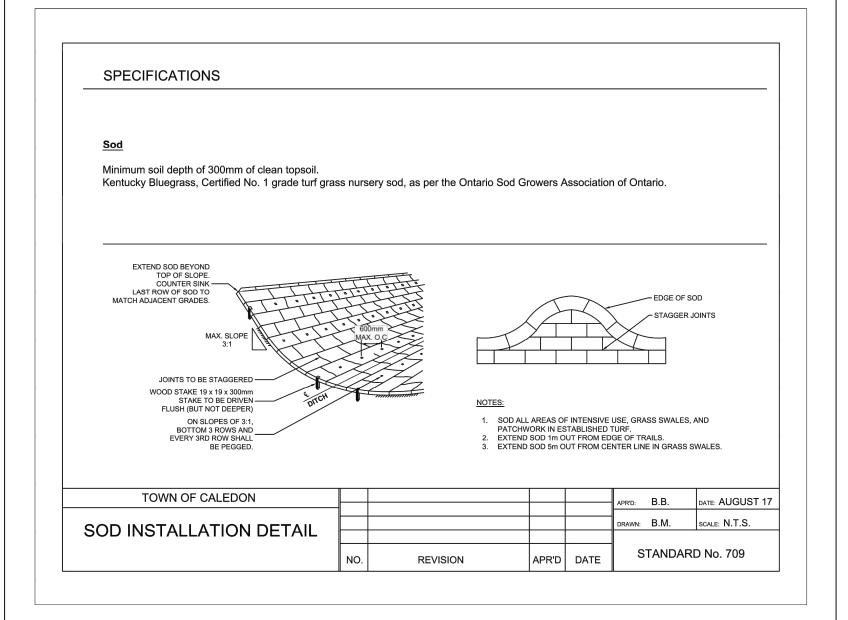







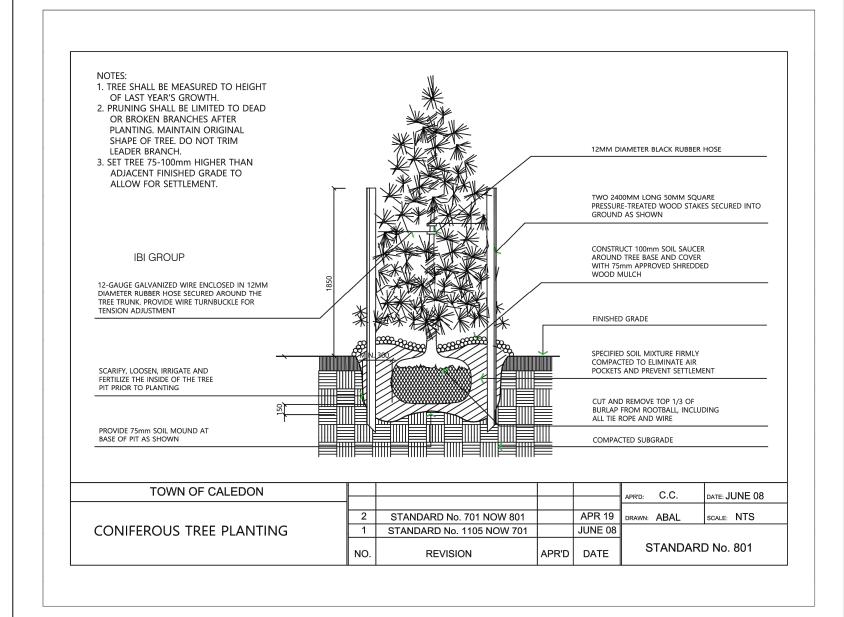

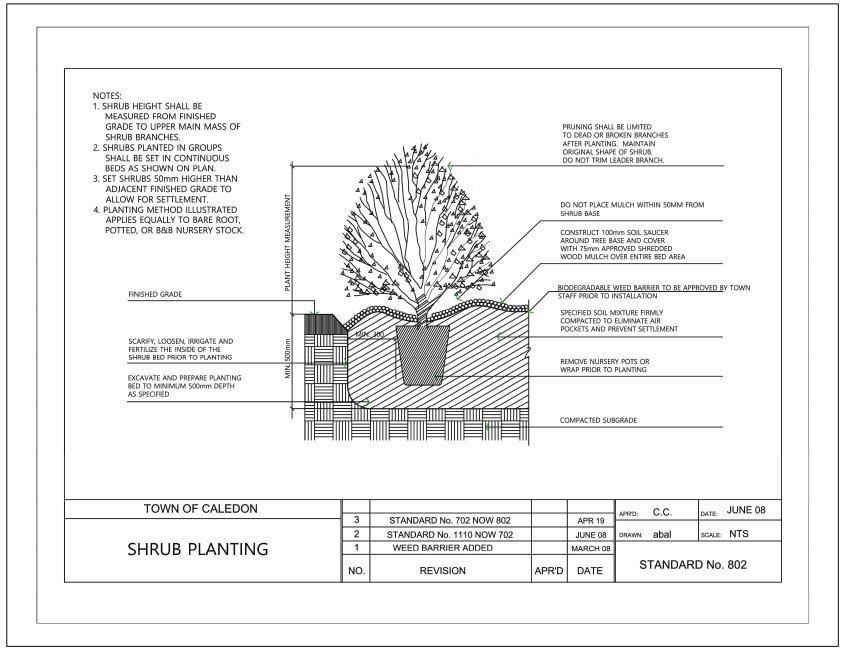

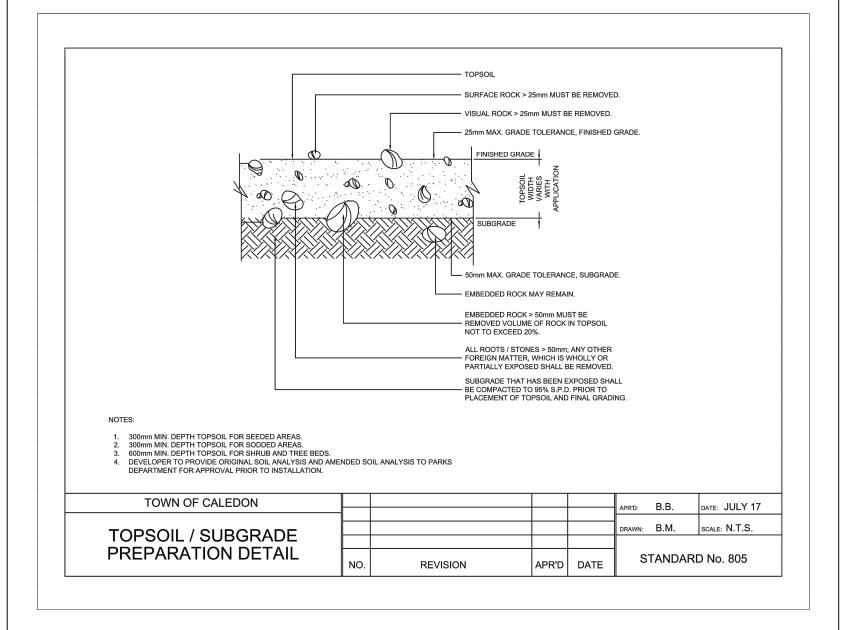

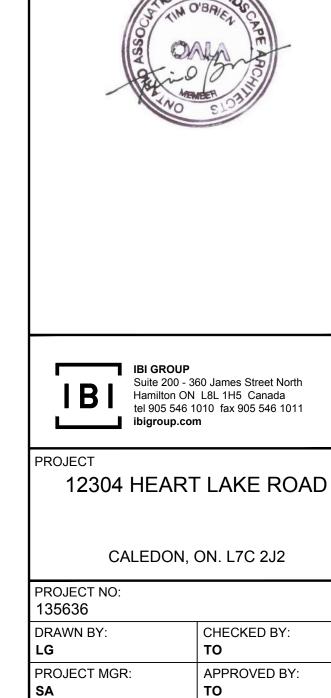

SHEET TITLE

SHEET NUMBER

LANDSCAPE DETAILS

ISSUE

SEAL